




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SCALE 1:100

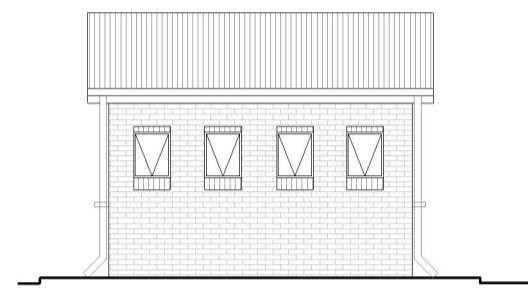


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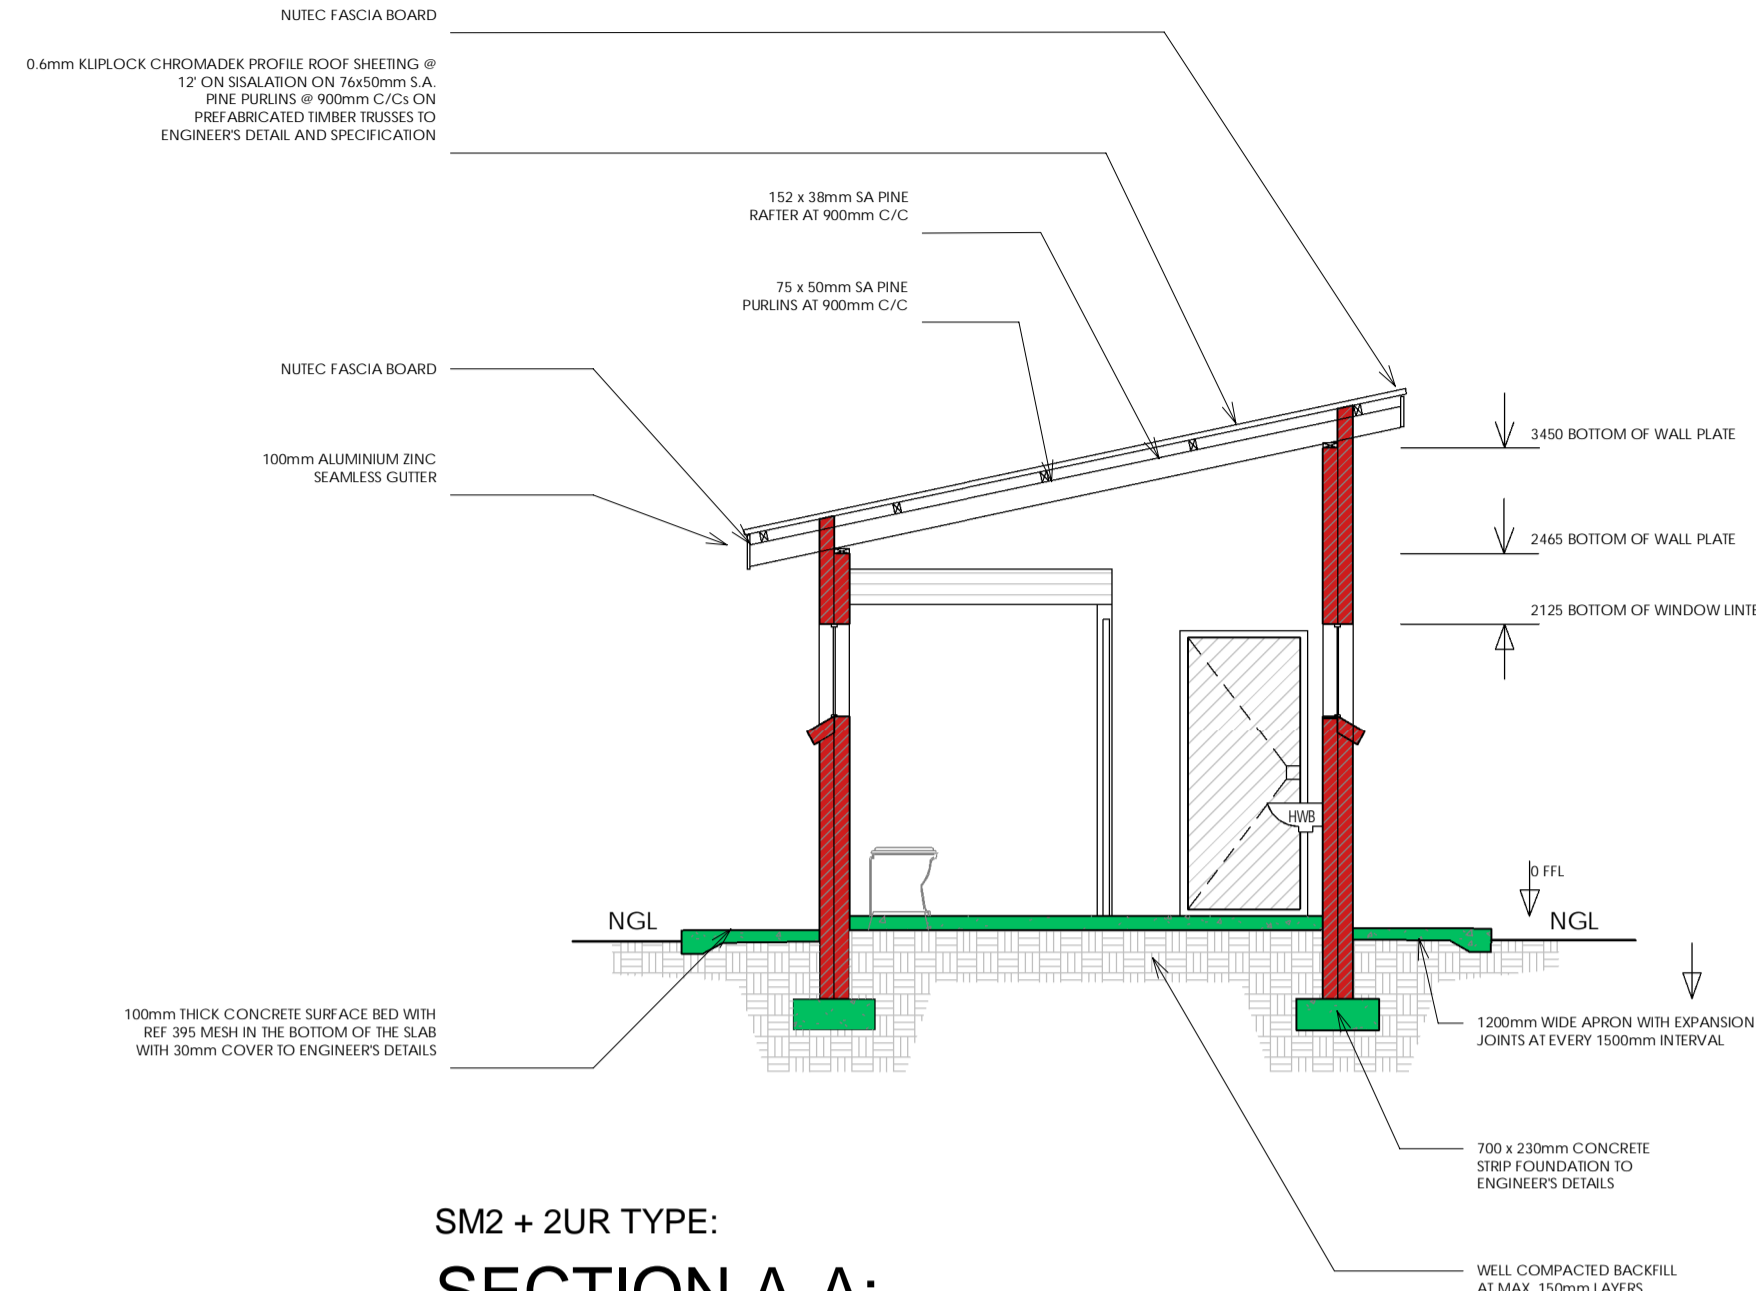
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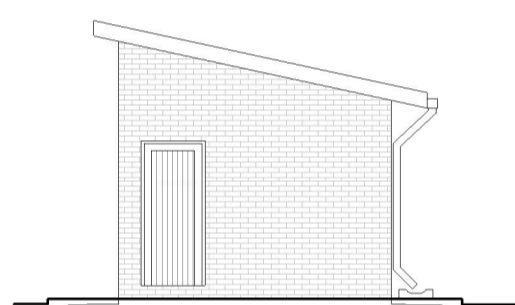
SM2 + 2UR TYPE:
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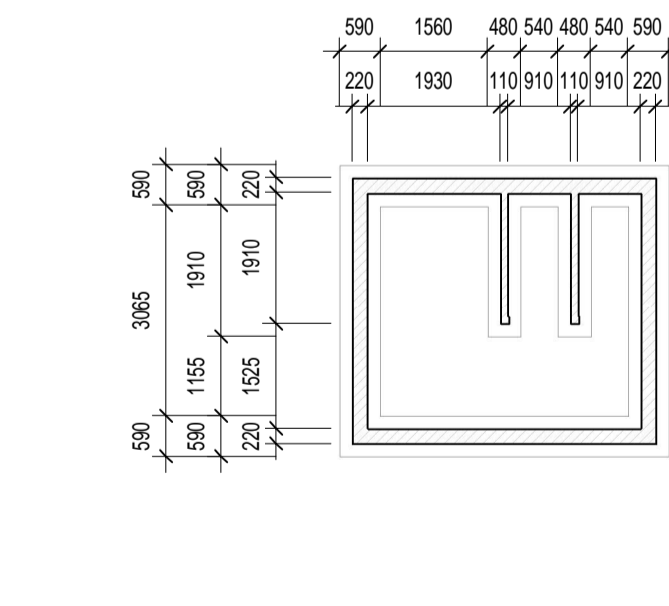
SM2 + 2UR TYPE:
SECTION A-A:
SCALE 1:50

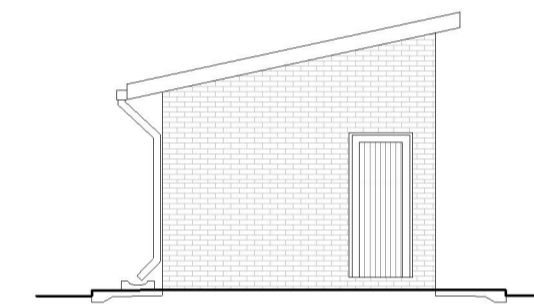

SM2 + 2UR TYPE:
SIDE ELEVATION:
SCALE 1:100

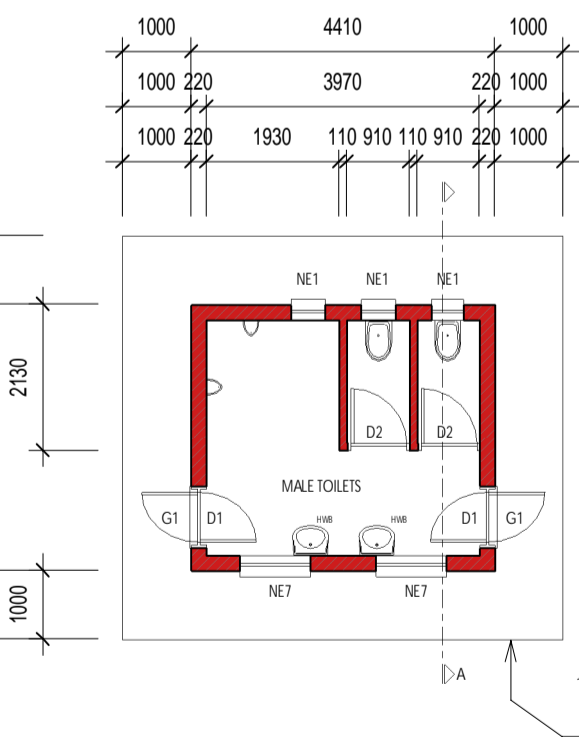

SM2 + 2UR TYPE:
FOUNDATION PLAN:
SCALE 1:100

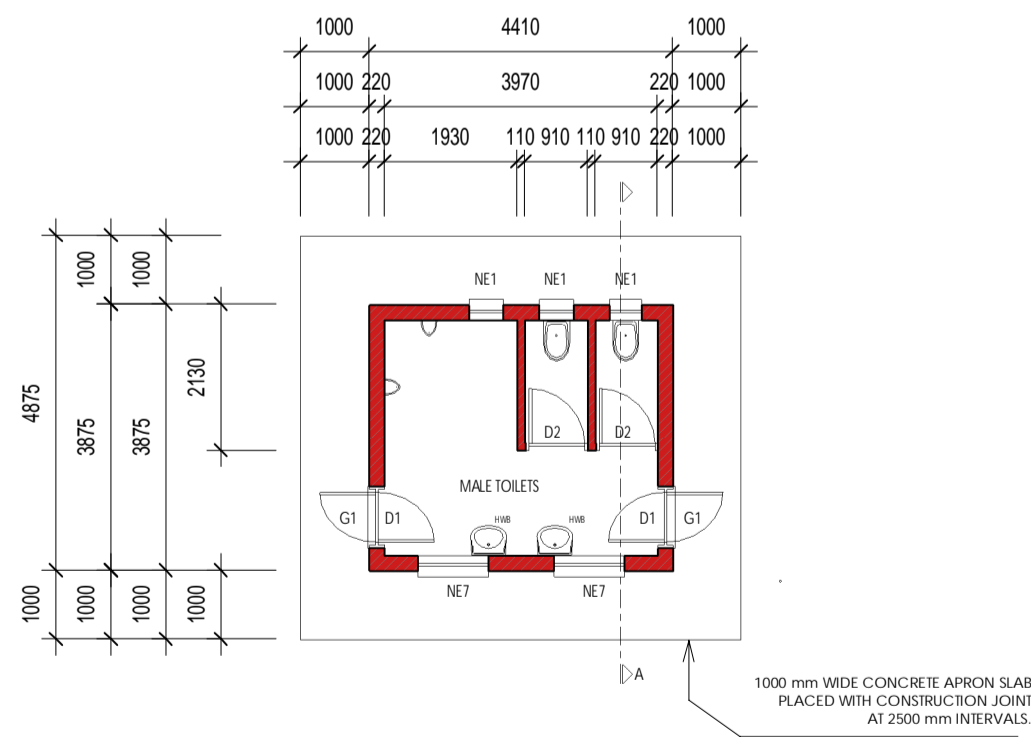

BUGLAR DOOR	
TYPE G1:	2 OFF:
POSITION:	EXTERNAL TOILET BLOCK
DOOR TYPE:	PURPOSE MADE SQUARE HOLLOW SECTION MILD STEEL SECURITY GATE
DOOR FINISH:	1x COAT ZINC CHROMATE PRIMER MINIMUM 2 x COATS GLOSS ENAMEL (EXTERNAL QUALITY)
FRAME:	500x814 40mm M.S. RECTANGULAR HOLLOW SECTION FRAME
FRAME FINISH:	1x COAT ZINC CHROMATE PRIMER MINIMUM 2 x COATS GLOSS ENAMEL (EXTERNAL QUALITY)
DOOR:	382x814 40mm RECTANGULAR HOLLOW SECTION FRAME WITH 2x20x14 INTERMEDIATES AT 100mm CENTERS AT A 45° ANGLE COLOUR TBC
IRONMONGERY:	SECURITY DOUBLE THROW DEAD LOCK (NO LATCH)

ENTRANCE DOOR	
TYPE D1:	2 OFF:
FRAME TYPE:	SINGLE REBATE STEEL FRAME TO FIT 220mm WALL (D1)
FRAME FINISH:	PRIME AND PAINT UNDERCOAT AND 2 COATS GLOSS ENAMEL COLOUR TBC
DOOR LEAF:	40mm FRAMED LEDGED AND BRACED DOOR SIZE 813x2025mm INCLUDING EXTERNAL WEATHER BAR
LEAF FINISH:	UNDER COAT AND MINIMUM 2 COATS GLOSS ENAMEL COLOUR TBC
LOCK:	1 LEVER NOTICE LOCK SET
IRONMONGERY:	100mm BRACE CABIN HOOK

CUBICLE DOOR	
TYPE D2:	2 OFF:
FRAME TYPE:	SINGLE REBATE STEEL DOOR FRAME SIZE 813x53mm (FRAME UNDERCUT TO 150mm)
FRAME FINISH:	PRIME AND PAINT UNDERCOAT AND 2 COATS GLOSS ENAMEL COLOUR TBC
DOOR LEAF:	40mm FRAMED LEDGED AND BRACED DOOR SIZE 813x2025mm (DOOR RAISE BY 150mm TO TOP OF FRAME)
LEAF FINISH:	UNDER COAT AND MINIMUM 2 COATS GLOSS ENAMEL COLOUR TBC
LOCK:	TOILET INDICATOR LOCK
IRONMONGERY:	100mm CHROME PLATED "D" TYPE HANDLE 3 BY SLOED BRACE HINGES

GENERAL NOTES AND SPECIFICATIONS:

- Use dimensions provided and do not scale drawing.
- All work to comply with SANS, PW371 and SABS.
- All dimensions, levels and positions to be verified on site prior to construction.
- All concrete work to be as per Engineer's details and specifications.
- All pits to face North.
- All brickwork have brickforce at every 2nd course in pit lining and 3rd course in superstructure.

- PIT EXCAVATION**
- All stages of pit excavation to be inspected and approved by Engineer and signed off.
 - All pit lining to be inspected by EnviroLoo Services before slab casting.

- COMPACTION OF SURFACES**
- All ground surfaces receiving concrete floors / slab should be compacted to 150mm layers 93% ModAASH10 density before casting concrete.

- CONCRETE WORKS**
- All concrete to be as per Engineer's details and specifications.
 - 25 MPa strength concrete to be used throughout construction. Trial Concrete Mixes: Proportions Concrete Strength at 28 Days 25Mpa: 1 : 2 : 2 (mix proportion by volume) 1 bag cement : 0.08m³ Sand : 0.09m³ Stone (Volume/Bag) 385 kg cement : 820 kg sand : 960 kg stone (Mass/m³)
 - Pre-cast concrete lintols to be used as support under top slab of pit.
 - All concrete aprons to be 1000mm wide. MORTAR Mixed proportions to be: 1 cement : 3 sand (i.e. 1 bag cement : 3 wheelbarrows (37 litres) sand)

- BRICKWORK** Sub-structure
- All pit lining / foundation brickwork to be solid NFP clay brick.
 - All internal surface of pit lining to be painted with two coats black epoxy paint installing Enviro-Loo units.

- Super-structure**
- All external walls / partitions to be of clay face brick to SABS quality.
 - All cubicle partition walls to be 3 courses above door height.
 - All brickwork above door openings should have brickforce on every course at least 3 courses.
 - Air bricks: Standard 230x152mm terra-colls vermin proofed louvered air grating to be used above all window openings.

- ROOF SHEETING**
- 0.6mm kilplock chromadek roof sheeting.

- ROOF TIMBER / CEILING**
- All roof timbers to be machined SABS treated wood with three coats of approved wood preservative.
 - Timber connections (Hurricane Clips) are required all intercessions between timber rafters and purlins.
 - Sisalation is to be applied interval under all roof surfaces.

- METALWORK**
- All metalwork should be primed before installation.
 - All steel window should have 6x20mm flat bar burglar proofing.

- PLUMBING**
- Double concrete wash trough to be used.
 - All wash troughs should be connected to the school's water supply system and the waste water should be piped to a soakaway.
 - The soakaway should be as per Engineer's detail and position to be determined on site.
 - Only 20mm and galvanised pipework should be used as connection from wall to the discharge points.

- GLAZING**
- 6.28mm obscure safety glass
 - Stainless steel mirrors size 350x450mm high.

- PAINTING**
- All paintwork to comply with SABS and PW371 specification.
 - All steel window and door frames including doors and fascia / barge boards to be discharge points.

NO	DATE	AMENDMENT	D.P.W

NOTES:

- All dimensions and levels are to be verified on site. Prior to the commencement of setting out, workshop drawings or construction, figures/dimensions to be used in preference to scaled dimensions. Any discrepancies, errors and omissions are to be reported to the architect immediately prior to commencing with any work.
- All shop drawings are to be submitted to the architect for approval prior to manufacture or installation.
- All work is to be executed in strict accordance with SANS CODES, BY-LAWS AND REGULATIONS OF THE LOCAL AUTHORITY, WHERE REQUIRED. ARCHITECTURAL DRAWINGS ARE TO BE READ IN CONJUNCTION WITH THE RELEVANT CONSULTANT'S DRAWINGS. COPYRIGHT AND RIGHT OF REPRODUCTION OF THIS DRAWING OR ANY PORTION THEREOF IS RESERVED AND REMAINS WITH GSA.
- All construction work must comply with the LAWS OF THE LAND, SANS 1040, THE NATIONAL BUILDING STANDARDS AND LOCAL AUTHORITY BY LAWS AND MODEL PREAMBLES.

KEYPLAN:

DEPARTMENT:

THE MVULA TRUST
A leading developmental NGO

SPONSOR:

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DWG FILE NAME:

ARCHITECT:

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FAX : 086 415 6426

DISCIPLINE: **CONTRACTOR:**

PROJECT:

TSHILWAVISUKU PRIMARY SCHOOL

LIMPOPO PROVINCE

DRAWING TITLE:
WATER-BORNE ABLUTIONS:

SM2 + 2UR TYPE:
REF NO: LE21TMT17202 DRAWN BY: K.M

SCALE: 1:100 CHECKED BY: K.M

DATE: 09.2023 VERIFIED BY: K.M

TYPE NUMBER: **SM2 + 2UR**

DWG NUMBER: **W100:SM2 + 2UR**