


SIDE ELEVATION: **SCALE 1:100**

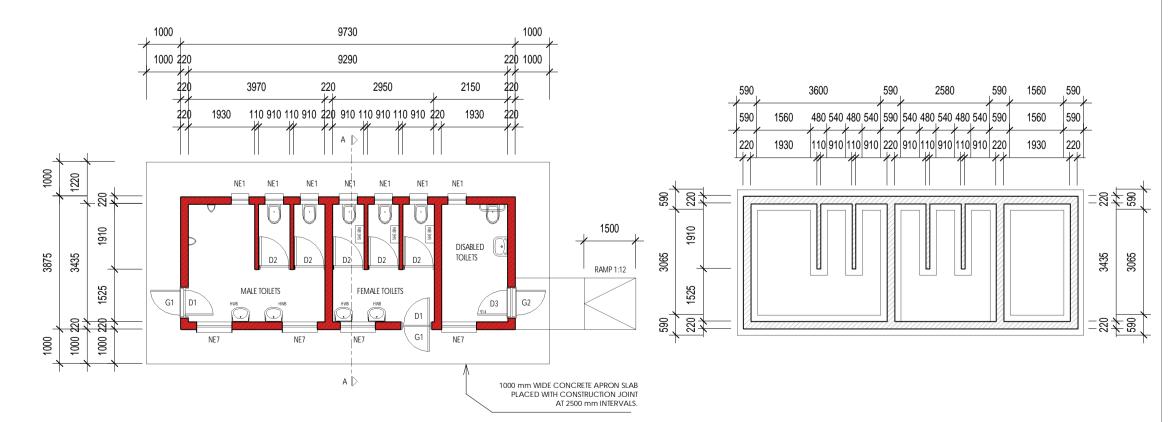

SFD3 + SM2 + 2UR TYPE:

FLOOR PLAN: **SCALE 1:100**

SFD3 + SM2 + 2UR TYPE:

SCALE 1:100

FOUNDATION PLAN: **SCALE 1:100**

NOTES AND SPECIFICATIONS:

All dimensions, levels and positions to be verified on site prior to

FRAME:

DOOR:

FRAME FINISH:

IRONMONGERY:

All concrete work to be as per Engineer's details and

All brickwork have brickforce at every 2nd course in pit lining and

All stages of pit excavation to be inspected and approved by

All pit lining to be inspected by EnviroLoo Services before slab

to 150mm layers 93% ModAASHTO density before casting concrete.

1. All concrete to be as per Engineer's details and specifications. 25 MPa strength concrete to be used throughout construction: Trial Concrete Mixes: Proportions Concrete Strenght at 28 Days 25Mpa: 1:2:2 (mix proportion by volume) 1 bag cement: 0.08m3 Sand: 0.09m3 Stone (Volume/Bag) 385 kg cement : 820 kg sand : 960 kg stone (Mass/m3)

Pre-cast concrete lintols to be used as support under top slab of pit. All concrete aprons to be 1000mm wide.. MORTAR Mixed proportions to be: 1 cement : 3 sand (i.e.1 bag cement : 3 wheelbarrows (37 litres) sand)

BRICKWORK Sub-structure

All pit lining / foundation brickwork to be solid NFP clay brick. All internal surface of pit lining to be painted with two coats black expoxy paint installing Enviro-Loo units.

Super-structure

All external walls / partitions to be of clay face brick to SABS quality. All cubicle partition walls to be 3 courses above door height. All brickwork above door openings should have brickforce on every

course at least 3 courses. Air bricks: Standard 230X152mm terra-colts vermin proofed lourved air grating to be used above all window openings.

ROOF SHEETING

1. 0.6mm kliplock chromadek roof sheeting.

All roof timbers to be machined SABS treated wood with three coats of approved wood preservative.

Timber connections (Hurricane Clips) are required all intercessions between timber rafters and purlins.

Sisalation is to be applied interval under all roof surfaces.

METALWORK

All metalwork should be primed before installation. All steel window should have 6x20mm flat bar burglar proofing.

Double concrete wash trough to be used. All wash troughs should be connected to the school's water supply


system and the waste water should be piped to a soakaway. The soakaway should be as per Engineer's detail and position to be determined on site.


Only 20mm and galvanised pipework should be used as connection from wall to the discharge points.

GLAZING


6.28mm obscure safety glass Stainless steel mirrors size 350x450mm high.

All paintwork to comply with SABS and PW371 specification. All steel window and door frames including doors and fascia / barge boards to be discharge points.

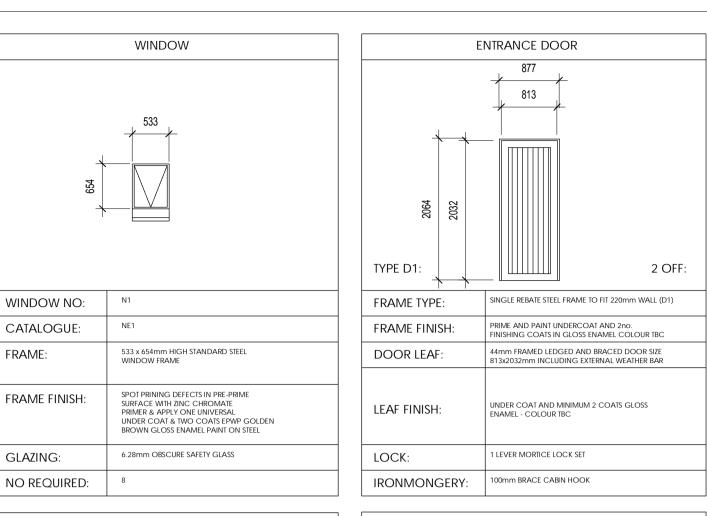

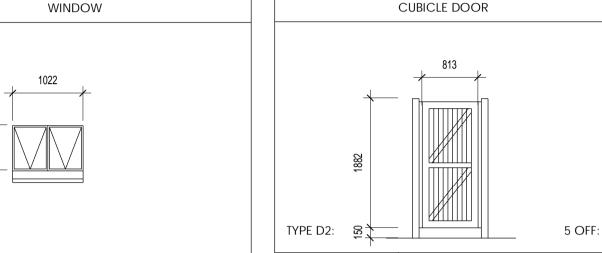

| 1 | | | ' | |
|---|---------------|--|---------------|--|
| Ì | WINDOW NO: | N2 | FRAME TYPE: | SINGLE REBATE STEEL DOOR FRAME - SIZE 83x53mm (FRAME UNDERCUT TO 150mm) |
| | CATALOGUE: | NE7 | FRAME FINISH: | PRIME AND PAINT UNDERCOAT AND 2 COATS- GLOSS ENAMEL - COLOUR TBC |
| | FRAME: | 1022 x 654mm HIGH STANDARD STEEL WINDOW FRAME | DOOR LEAF: | 44mm FRAMED LEDGED EMBRACED DOOR SIZE 813x2032mm (DOOR RAISE BY 150mm TO TOP OF FRA |
| | FRAME FINISH: | SPOT PRINING DEFECTS IN PRE-PRIME SURFACE WITH ZINC CHROMATE PRIMER & APPLY ONE UNIVERSAL UNDER COAT & TWO COATS EPWP GOLDEN BROWN GLOSS ENAMEL PAINT ON STEEL | LEAF FINISH: | UNDER COAT AND MINIMUM 2 COATS GLOSS ENAMEL - COLOUR TBC |
| | GLAZING: | 6.28mm OBSCURE SAFETY GLASS | LOCK: | TOILET INDICATOR LOCK |
| İ | NO REQUIRED: | 4 | IRONMONGERY: | 100mm CHROME PLATED "D" TYPE HANDLE 3 BY SOLID BRACE HINGES |
| | | | | |

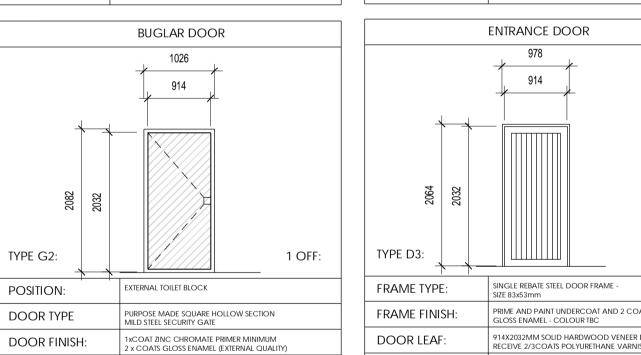



50x38x1.6mm M.S. RECTANGULAR HOLLOW SECTION FRAME


1xCOAT ZINC CHROMATE PRIMER MINIMUM 2 x COATS GLOSS ENAMEL (EXTERIOR

SECURITY DOUBLE THROW DEAD LOCK (NO LATCH)

38x28x1.6mm RECTANGULAR HOLLOW SECTION FRAME WITH 25x25x1.6 INTERMEDIATES AT 100m CENTERS AT A 45° ANGLE COLOUR TBC

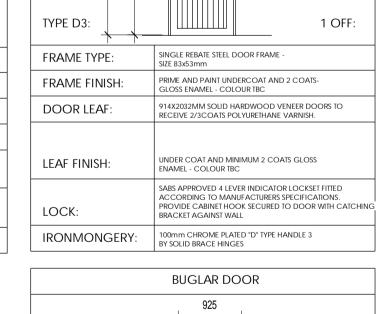

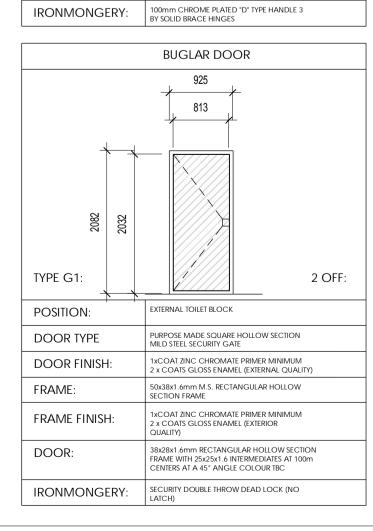

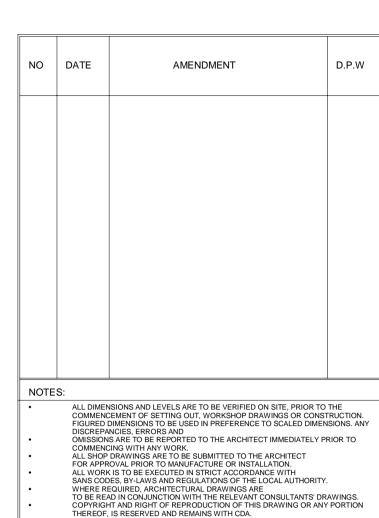

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CONTRACTOR:

LOGO:

ITIRELENG SECONDARY SCHOOL

LIMPOPO PROVINCE

DRAWING TITLE: **WATER-BORNE ABLUTIONS:**

SFD3 + SM2 + 2UR TYPE: REF NO: LE20TMT17058 DRAWN BY: K.M CHECKED BY: K.M SCALE: 1:100 **VERIFIED BY: K.M** DATE: **09.2023**

SFD3 + SM2 + 2URDWG NUMBER: W100:SFD3+SM2+2UR