


SLAB EDGE THICKENING DETAIL




DETAIL TB

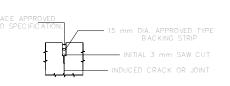


150 mm THICK RIP & RECOMPACT INSITU NOTE: MATERIAL TO 93% MOD. AASHTO AT OMC LAYERWORKS ASSUMES AN INSITU CBR > 15.

LAYERWORKS DETAIL: SURFACEBED

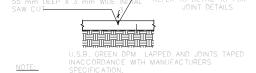

SAW CUT JOINT (S.J)



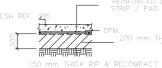

150 mm THICK RIP & RECOMPACT INSITU MATERIAL TO 93% MOD. AASHTO AT OMC

LAYERWORKS DETAILS: FOUNDATIONS

NOTES:

COVER TO REINFORCEMENT TO BE 25 mm UNLESS OTHERWISE INDICATED.

LAP LENGTHS TO BE 45 x Ø.

ANCHORAGE LENGTHS TO BE 45 x Ø.

CONTRACTOR TO ENSURE BOND BREAKER IS USED BETWEEN VERTICAL CONCRETE FACE AND

CONCRETE E.G POLYSTYRENE OR SOFT—BOARD
CONTRACTOR TO ENSURE PLASTIC IS USED

BETWEEN BRICK WALLS AND CONCRETE CONCRETE TO BE 25MPA

EXAMPLE OF BAR CALL-OFF:

20 Y25-63-150 T2

20 - NUMBER OF BARS Y - TYPE OF REINFORCEMENT

25 - DIAMETER (mm) 63 – BAR MARK NUMBER

150- SPACING C/C (mm)
T2 - PLACING DESCRIPTION (SEE BELOW)



LEGEND:

NF - NFAR FACE T - TOP - FAR FACE B - BOTTOM EF - EACH FACE EW - EACH WAY M - MIDDLE IF - INSIDE FACE

B1

ALT — ALTERNATE HOR — HORIZONTAL OF - OUTSIDE FACE STG - STAGGERED TOG - TOGETHER CTF - CUT TO FIT VERT - CENTRES MEASURED VERTICALLY

CTL - CUT TO LENGTH U - U-BARS HC - HIGH CHAIR

ABR - ALTERNATE BARS REVERSED CHC - CONTINUOUS HIGH CHAIR

CJ - CONSTRUCTION JOINT OCJ - OPTIONAL CONSTRUCTION JOINT

EJ - EXPANSION JOINT





RMC QUANTITY SURVEYORS

MAGAEDISHA HIGH SCHOOL FEMALE EDUCATORS ENVIRO LOO

STRUCTURAL DETAILS FOR FOUNDATIONS AND FLOOR SLABS


I.MOHAMED (PR ENG 20180160)


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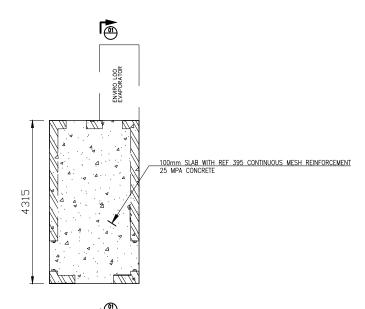
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1 OF 1


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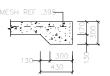




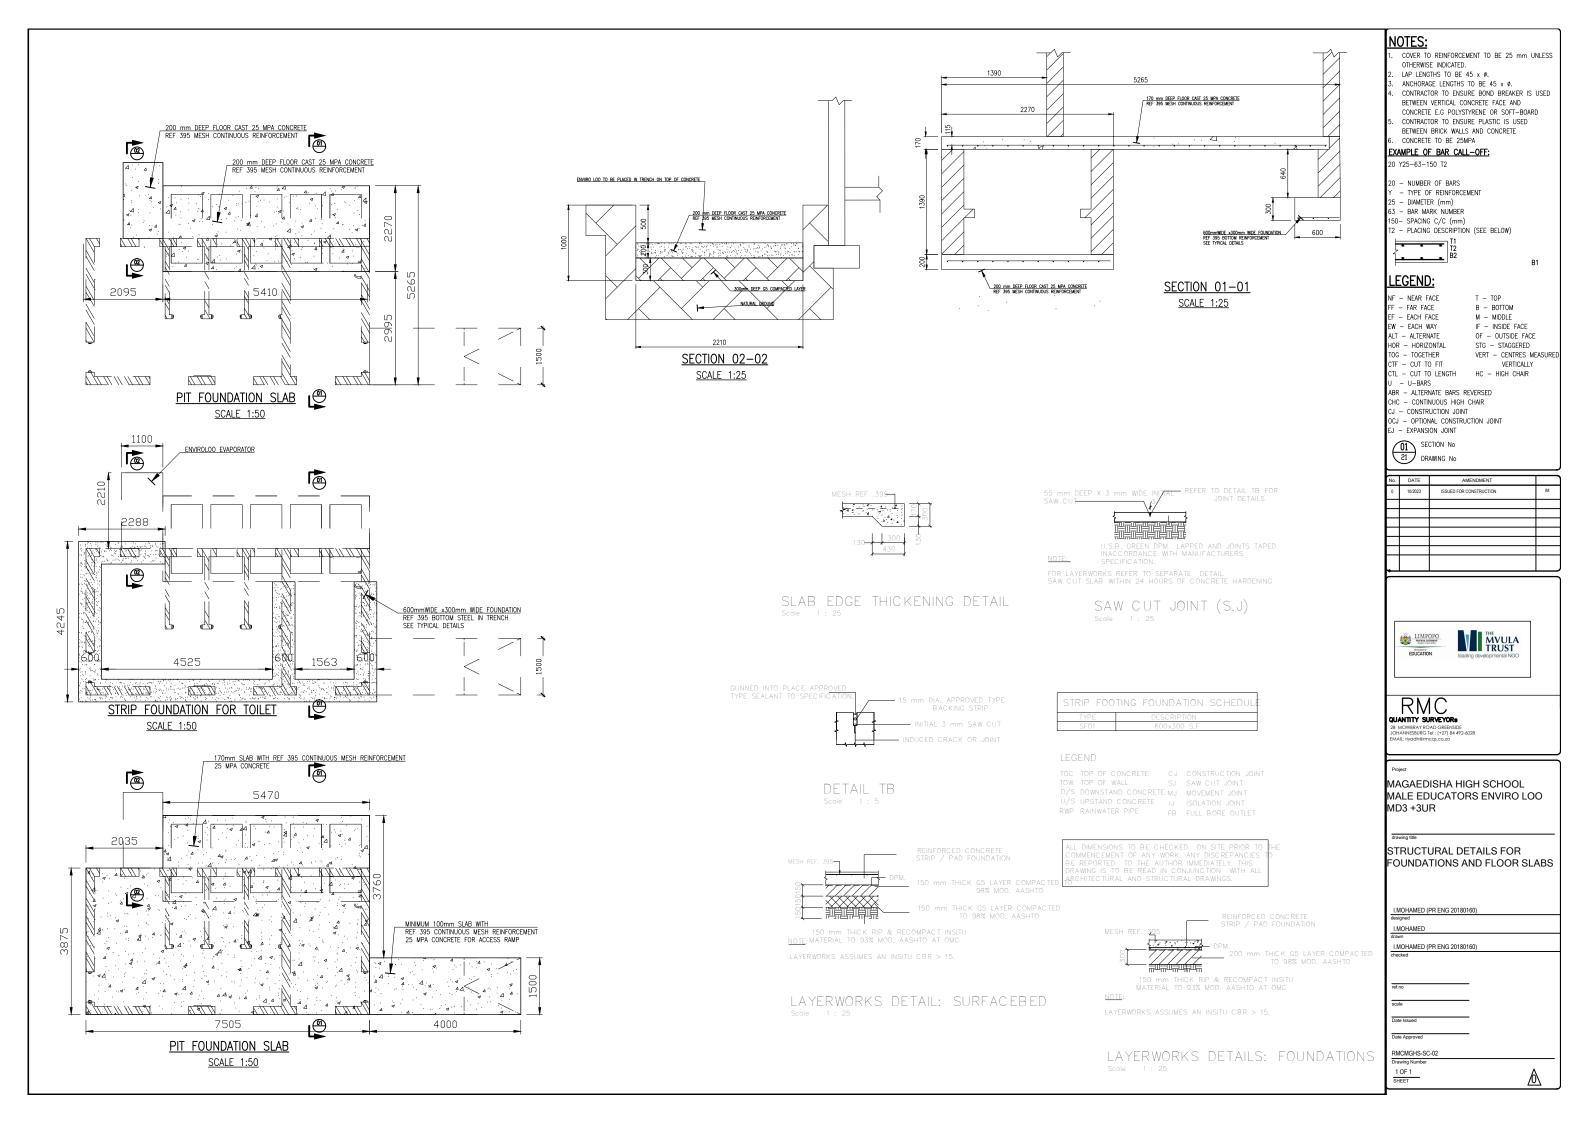


® GROUND FLOOR SLAB FOR URINALS SCALE 1:50

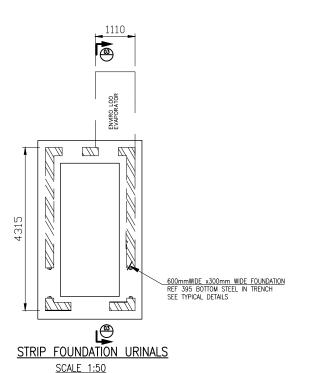


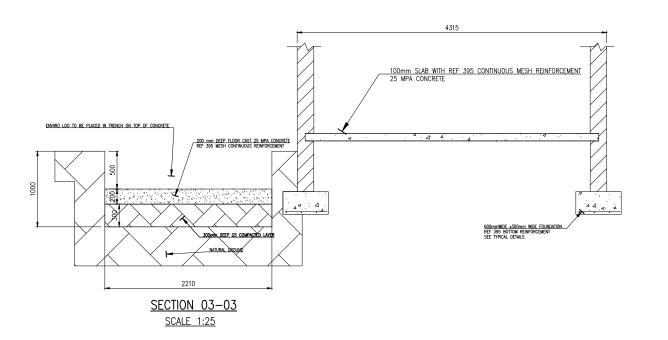

SLAB EDGE THICKENING DETAIL

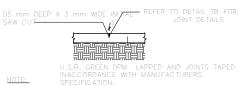

SAW CUT JOINT (S.J)

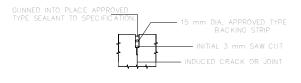


DETAIL TB



TOC TOP OF CONCRETE CJ CONSTRUCTION JOINT TOW TOP OF WALL SJ SAW CUT JOINT D/S DOWNSTAND CONCRETE MJ MOVEMENT JOINT D/S DOWNSTAND CONCRETE MU
U/S UPSTAND CONCRETE IJ ISOLATION JOINT
RWP RAINWATER PIPE FB FULL BORE OUTLET

150 mm THICK RIP & RECOMPACT INSIT

LAYERWORKS DETAIL: SURFACEBED

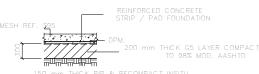

LAYERWORKS DETAILS: FOUNDATIONS

NOTES:

COVER TO REINFORCEMENT TO BE 25 mm UNLESS OTHERWISE INDICATED.

LAP LENGTHS TO BE 45 x Ø.

ANCHORAGE LENGTHS TO BE 45 x Ø. CONTRACTOR TO ENSURE BOND BREAKER IS USED BETWEEN VERTICAL CONCRETE FACE AND

CONCRETE E.G POLYSTYRENE OR SOFT-BOARD CONTRACTOR TO ENSURE PLASTIC IS USED BETWEEN BRICK WALLS AND CONCRETE

CONCRETE TO BE 25MPA EXAMPLE OF BAR CALL-OFF:

20 Y25-63-150 T2

20 - NUMBER OF BARS Y - TYPE OF REINFORCEMENT

25 - DIAMETER (mm)

63 - BAR MARK NUMBER

T2 - PLACING DESCRIPTION (SEE BELOW)



<u>LEGEND:</u>


NF - NFAR FACE T - TOP - FAR FACE B - BOTTOM EF - EACH FACE EW - EACH WAY M - MIDDLE IF - INSIDE FACE ALT — ALTERNATE HOR — HORIZONTAL OF - OUTSIDE FACE STG - STAGGERED

TOG - TOGETHER CTF - CUT TO FIT VERT - CENTRES MEASURED VERTICALLY

CTL - CUT TO LENGTH U - U-BARS HC - HIGH CHAIR

ABR — ALTERNATE BARS REVERSED CHC — CONTINUOUS HIGH CHAIR CJ - CONSTRUCTION JOINT

OCJ - OPTIONAL CONSTRUCTION JOINT EJ - EXPANSION JOINT

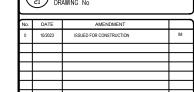



RMC QUANTITY SURVEYOR®

MAGAEDISHA HIGH SCHOOL BOYS URINALS ENVIRO LOO


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STRUCTURAL DETAILS FOR FOUNDATIONS AND FLOOR SLABS

I.MOHAMED (PR ENG 20180160) I.MOHAMED I.MOHAMED (PR ENG 20180160)

RMCMGHS-SC-03 1 OF 1



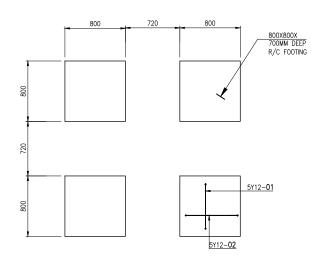



MEMBER	NO OF	NO BARS	DIA	CUT LENGTH	TOTAL	BAR MARK	sc	Α	В	С	D	E/R	kg
FOUNDATION	4	5	Y12	2700	20	01	60	700	600				48
	4	5	Y12	2650	20	02	60	700	570				47

	6	8	10	12	16	20	25	32	40	TOTAL
R										
Υ				95						95
TOTAL				95						95

TANK STAND FOUNDATION DETAIL

SCALE 1:25

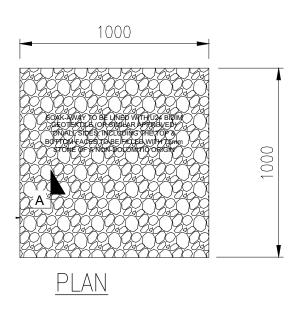

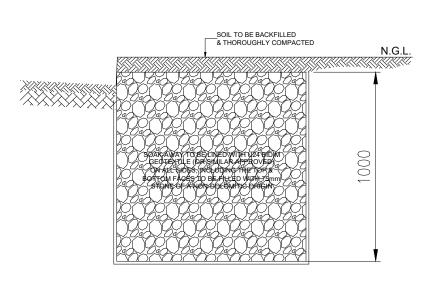

SECTION

TYPICAL SOAKAWAY DETAIL SCALE 1:10

<u> 10TES:</u>

- COVER TO REINFORCEMENT TO BE 25 mm UNLESS OTHERWISE INDICATED.

- LAP LENGTHS TO BE 45 x Ø.
 ANCHORAGE LENGTHS TO BE 45 x Ø.
 CONTRACTOR TO ENSURE BOND BREAKER IS USED
 BETWEEN VERTICAL CONCRETE FACE AND
- CONCRETE E.G POLYSTYRENE OR SOFT-BOARD
 CONTRACTOR TO ENSURE PLASTIC IS USED
- BETWEEN BRICK WALLS AND CONCRETE
 CONCRETE TO BE 25MPA
- EXAMPLE OF BAR CALL-OFF:

20 Y25-63-150 T2

- 20 NUMBER OF BARS Y TYPE OF REINFORCEMENT
- 25 DIAMETER (mm)
- 63 BAR MARK NUMBER
- 150- SPACING C/C (mm)
 T2 PLACING DESCRIPTION (SEE BELOW)



LEGEND:

NF - NEAR FACE - FAR FACE B - BOTTOM FF — FAR FACE
EF — EACH FACE
EW — EACH WAY
ALT — ALTERNATE
HOR — HORIZONTAL M - MIDDLE IF - INSIDE FACE

OF - OUTSIDE FACE STG - STAGGERED TOG = TOGETHER VERT =
CTF = CUT TO FIT
CTL = CUT TO LENGTH HC = H
U = U-BARS
ABR = ALTERNATE BARS REVERSED
CHC = CONTINUOUS HIGH CHAIR VERT - CENTRES MEASURED VERTICALLY

HC - HIGH CHAIR

- CJ CONSTRUCTION JOINT OCJ OPTIONAL CONSTRUCTION JOINT EJ - EXPANSION JOINT



RMC QUANTITY SURVEYOR®

MAGAEDISHA HIGH SCHOOL TYPICAL WATER TOWER

FOUNDATION TYPICAL SOAKAWAY DETAIL


STRUCTURAL DETAILS


I.MOHAMED (PR ENG 20180160)

I.MOHAMED (PR ENG 20180160)

RMCMGHS-SC-04 Drawing Number



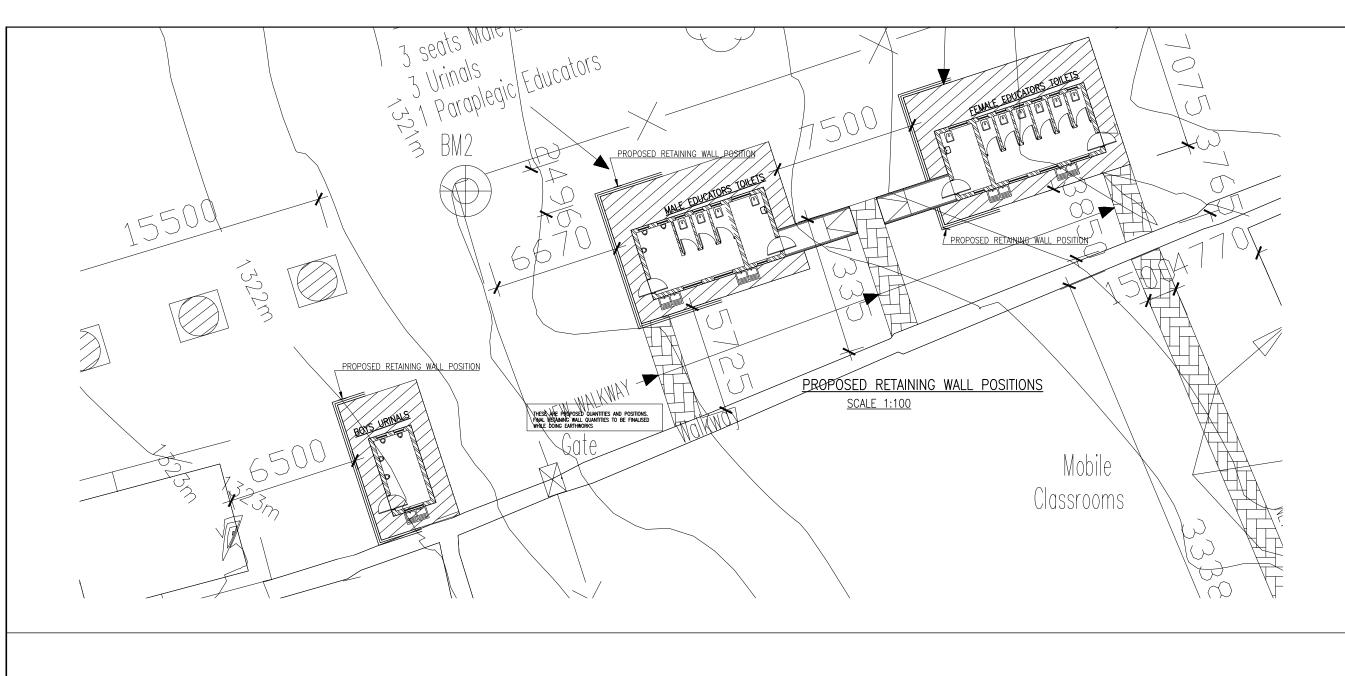

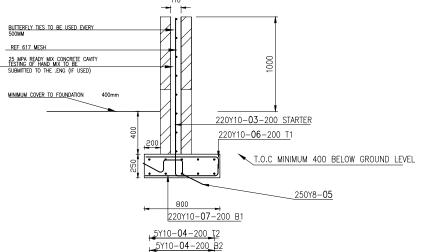

1m HIGH CAVITY RETAINING WALL DETAIL SCALE 1:20

S EVERY 3rd COURSE TO HAVE BRICK FORCE BUTTERFLY TIES TO BE USED EVERY 500MM MESH REINFORCEMENT IS CONTINUOUS IS IN THE WALL

MEMBER	NO OF	NO BARS	DIA	CUT LENGTH	TOTAL	BAR MARK	sc	А	В	С	D	E/F	:	kg
1m WALL	1	220	Y10	900	220	03	37	120	[820]				Т	122
	1	40	Y10	12000	40	04	20	[12000]					П	296
	1	250	Y8	900	250	05	83	200	150	250	[250]		П	89
	1	220	Y10	850	220	06	37	760	[120]				П	115
	1	220	Y10	850	220	07	37	120	[760]				П	115
	6		3	10	12	1	6	20	25	3.	2	40	TO	TAL
R														
Y		8	9	649									7	37
TOTAL		8	9	649									7	37

S
CALCS BASED ON 40m of RETAINING WALL
44 m2 OF REF 617 MESH REQUIRED
MESH TO 14ME MINNAUM OVERLAP OF 400mm
THE CONTRACTOR MAY SUBSTITUTE MESH WITH Y10 @200

- CONCRETE TO BE CAST IN 0.5m LIFTS
 HEIGHTS ARE INDICATIVE AND MAY VARY ON SITE
- APPROX LENGTH OF WALL 40m
 FOUNDATION TO HAVE MIN COVER OF 0.4m TO NGI

<u> 10TES:</u>

- COVER TO REINFORCEMENT TO BE 25 mm UNLESS OTHERWISE INDICATED.
- LAP LENGTHS TO BE 45 x Ø.

 ANCHORAGE LENGTHS TO BE 45 x Ø.
- CONTRACTOR TO ENSURE BOND BREAKER IS USED BETWEEN VERTICAL CONCRETE FACE AND
- CONCRETE E.G POLYSTYRENE OR SOFT-BOARD
- CONTRACTOR TO ENSURE PLASTIC IS USED BETWEEN BRICK WALLS AND CONCRETE

CONCRETE TO BE 25MPA EXAMPLE OF BAR CALL-OFF:

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20 - NUMBER OF BARS Y - TYPE OF REINFORCEMENT

25 - DIAMETER (mm) 63 - BAR MARK NUMBER

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EGEND:

NF - NEAR FACE - FAR FACE B - BOTTOM EF - EACH FACE EW - EACH WAY M - MIDDLE IF - INSIDE FACE ALT – ALTERNATE HOR – HORIZONTAL OF - OUTSIDE FACE STG - STAGGERED

TOG - TOGETHER CTF - CUT TO FIT VERT - CENTRES MEASURED VERTICALLY HC - HIGH CHAIR

CTL - CUT TO LENGTH U - U-BARS

ABR — ALTERNATE BARS REVERSED CHC — CONTINUOUS HIGH CHAIR

CJ - CONSTRUCTION JOINT OCJ - OPTIONAL CONSTRUCTION JOINT

EJ - EXPANSION JOINT







RMC QUANTITY SURVEYOR®

MAGAEDISHA HIGH SCHOOL RETAINING WALL SITE PLAN AND DETAILS

STRUCTURAL DETAILS RETAINING WALLS AROUND TOILET BLOCKS

I.MOHAMED (PR ENG 20180160)

I.MOHAMED

I.MOHAMED (PR ENG 20180160)

RMCMGHS-SC-05 Drawing Number 1 OF 1

