ITEM No.	DRAWING No.	DRAWING TITLE
1	C1546-00	LIST OF DRAWINGS
2	C1546-01	GENERAL SITE PLAN SHEET 1 OF 2
3	C1546-02	GENERAL SITE PLAN SHEET 2 OF 2
4	C1546-03	WATER LAYOUT
5	C1546-04	WATER DETAIL
6	C1546-05	SEWER LAYOUT
7	C1546-06	SEWER LONGITUDINAL SECTIONS SHEET 1
8	C1546-07	SEWER LONGITUDINAL SECTIONS SHEET 2
9	C1546-08	SEWER DETAILS SHEET 1
10	C1546-09	SEWER DETAILS SHEET 2
11	C1546-10	PACKAGE TREATMENT PLANT AND SIGNAL HOUSE



No.	DATE	AMENDMENT	D.P.W.
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	*	public works	
		Department: Publick Works REPUBLIC OF SOUTH AFRICA	
Con	sultant		
	3		
Office Pinew	F10, 33 Riley Ro ood Office Park	Fax : (011) 234 014	6
	ipline CIVIL	Email: admin@bmkg –	roup.co.za
P/ RE	AFURI L/ ELOCAT	AND PORT OF ENTR ION OF WET SERVIC	ES
		WAY FOR THE SOLA ANEL PROJECT	٩K
	roved by Desi	gn Leader	
PR	. TECH.		
WC	S number	052476	
drav	ving title		ļ
	-	RAWINGS	
	ST OF D	RAWINGS designed TT MPHOL drawn H MALUWA checked T RAM IOC	



SCALE 1:1 000

## LEGEND:

СТ TP WR EXISTING FRENCH DRAIN MC/PH

NEW SOLAR PANEL FOOTPRINT

SEWER MANHOLE CONSERVANCY TANK PUMP PACKAGE TREATMENT PLANT 110mm Ø SEWER PIPE EXISTING SEWER PIPE

EXISTING LOCATION FOR PH1 & NEW LOCATION FOR PH2

EXISTING SEPTIC TANK

1:200 OBSERVED FLOOD LEVEL

1:100 OBSERVED FLOOD LEVEL

HC - HOUSE CONNECTION

PACKAGE TREATMENT PLANT FOOTPRINT

## SEPTIC TANK COORDINATES WGS84 DATUM Lo 31°

SEPTIC TANK NAME	Y	Х
S1	-32 118.336	2 483 444.865
S2	-32 151.440	2 483 441.184
S3	-32 182.794	2 483 446.141
S4	-32 214.480	2 483 458.651
S5	-32 219.745	2 483 529.896
S6	-32 217.814	2 483 436.107
S7	-32 246.326	2 483 436.220
S8	-32 323.618	2 483 465.799
S9	-32 321.364	2 483 469.135
S10	-32 321.046	2 483 472.418
S11	-32 421.966	2 483 484.728
S12	-32 421.469	2 483 488.119
S13	-32 421.078	2 483 543.823
S14	-32 374.832	2 483 516.514
S15	-32 313.201	2 483 521.301
S16	-32 312.756	2 483 524.757

# COMMUNICATION TOWER TELEPHONE POLE MOBILE HOME/PARK HOME


HC

CC	E BOL DORDI 34 DAT
POSITION	Y
A	-32 081.4
В	-32 129.
С	-32 126.2
D	-32 251.3
E	-32 134.:
F	-32 259.3
G	-32 254.8
Н	-32 464.9
I	-32 505.4
J	-32 401.
К	-32 342.9
L	-32 201.3
М	-32 203.2
N	-32 067.



## **BENCH MARK** SETTING OUT COORDINATES WGS84 DATUM Lo 31°

BENCH MARK	Y	Х	Z
BM1	-32 111.681	2 483 504.578	202.921
BM2	-32 283.767	2 483 540.102	199.249
BM3	-32 502.479	2 483 576.761	196.267

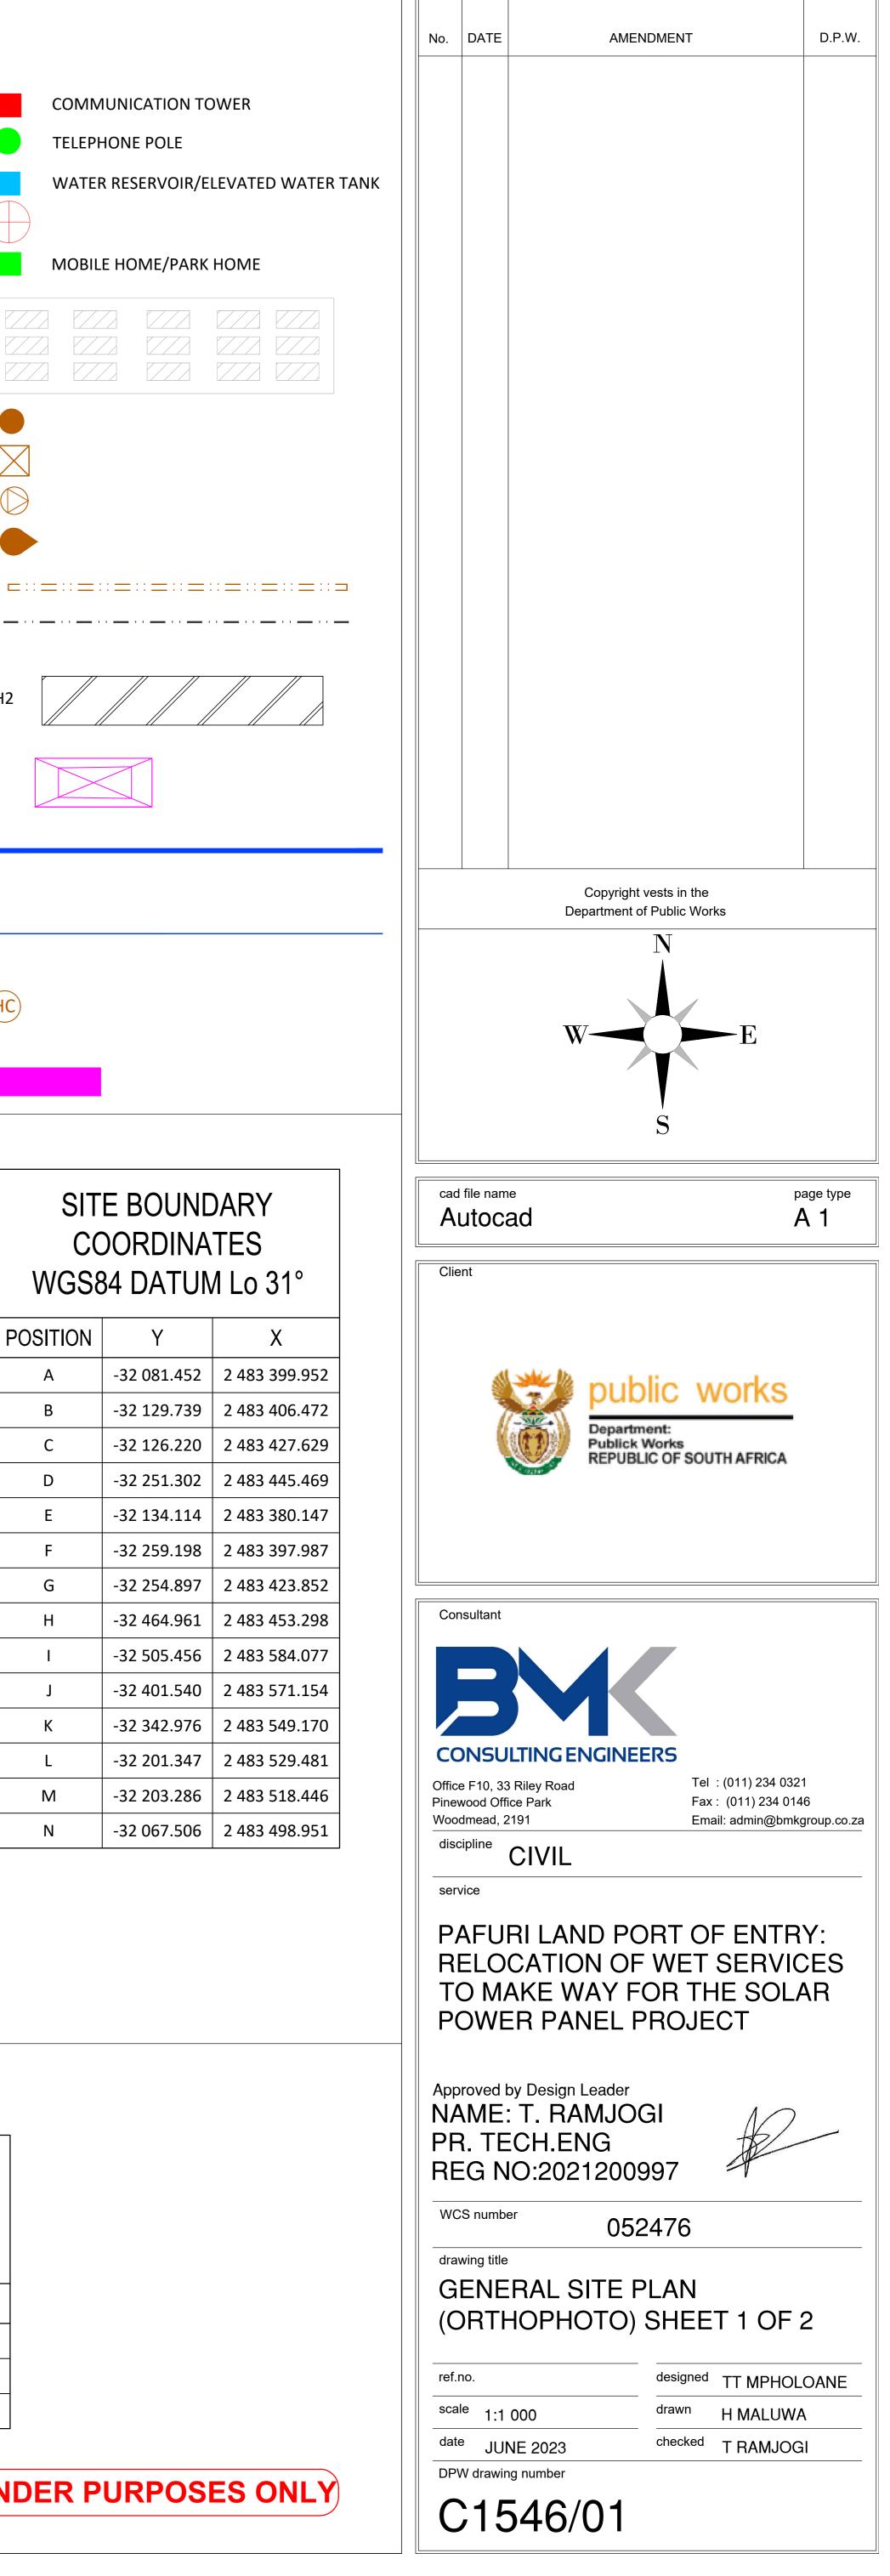

- PROFESSIONAL LAND SURVEYOR.


- STRUCTURAL ENGINEERING AND ARCHITECTURAL
- WORKS CONSTRUCTED UPON COMPLETION OF THE
- THE RELEVANT SABS 1200 SPECIFICATIONS.
- THE CONTRACTOR MUST GIVE THE ENGINEER 48 HOURS UP ANY WORKS.
- TESTING AT FREQUENCIES SPECIFIED IN THE RELEVANT SANS 1200 SPECIFICATIONS. COSTS FOR CONTROL TESTING WILL BE FOR THE CONTRACTORS ACCOUNT
- COMMENCING WITH CONSTRUCTION. DISCREPANCIES IN THE DRAWINGS, THESE DISCREPANCIES MUST BE BROUGHT TO THE ATTENTION
- OTHER THAN THOSE SPECIFIED, HE MUST OBTAIN
- ISSUED UNDER SITE INSTRUCTION, AFTER APPROVAL BY THE PRINCIPAL AGENT
- 14. ALL BRICKS USED TO CONSTRUCT SEWER AND BRICKS CONFORMING TO SANS 1200 LD.
- BY THE CONTRACTOR AND IS SHOWN ON THE CONSTRUCTION DRAWINGS OR INDICATED TO THE CONTRACTOR ON SITE BY THE ENGINEER, MUST BE


- INDICATED BY THE ENGINEER.
- MOD. AASHTO DENSITY.


- BEDDING.
- STANDARDS
- ALL ROUND WITH 25MPa CONCRETE AT 28 DAYS STRENGTH.

- 1. BULK WATER MAIN : 50mm Ø uPVC CLASS 10


- 28 DAYS STRENGTH.
- ARE CONNECTED TO THE POTABLE WATER **RETICULATION AND NOT THE FIRE**
- INDICATE TO THE RELEVANT UNDERGROUND
- 800mm, EXCEPT AT ROAD CROSSINGS WHERE

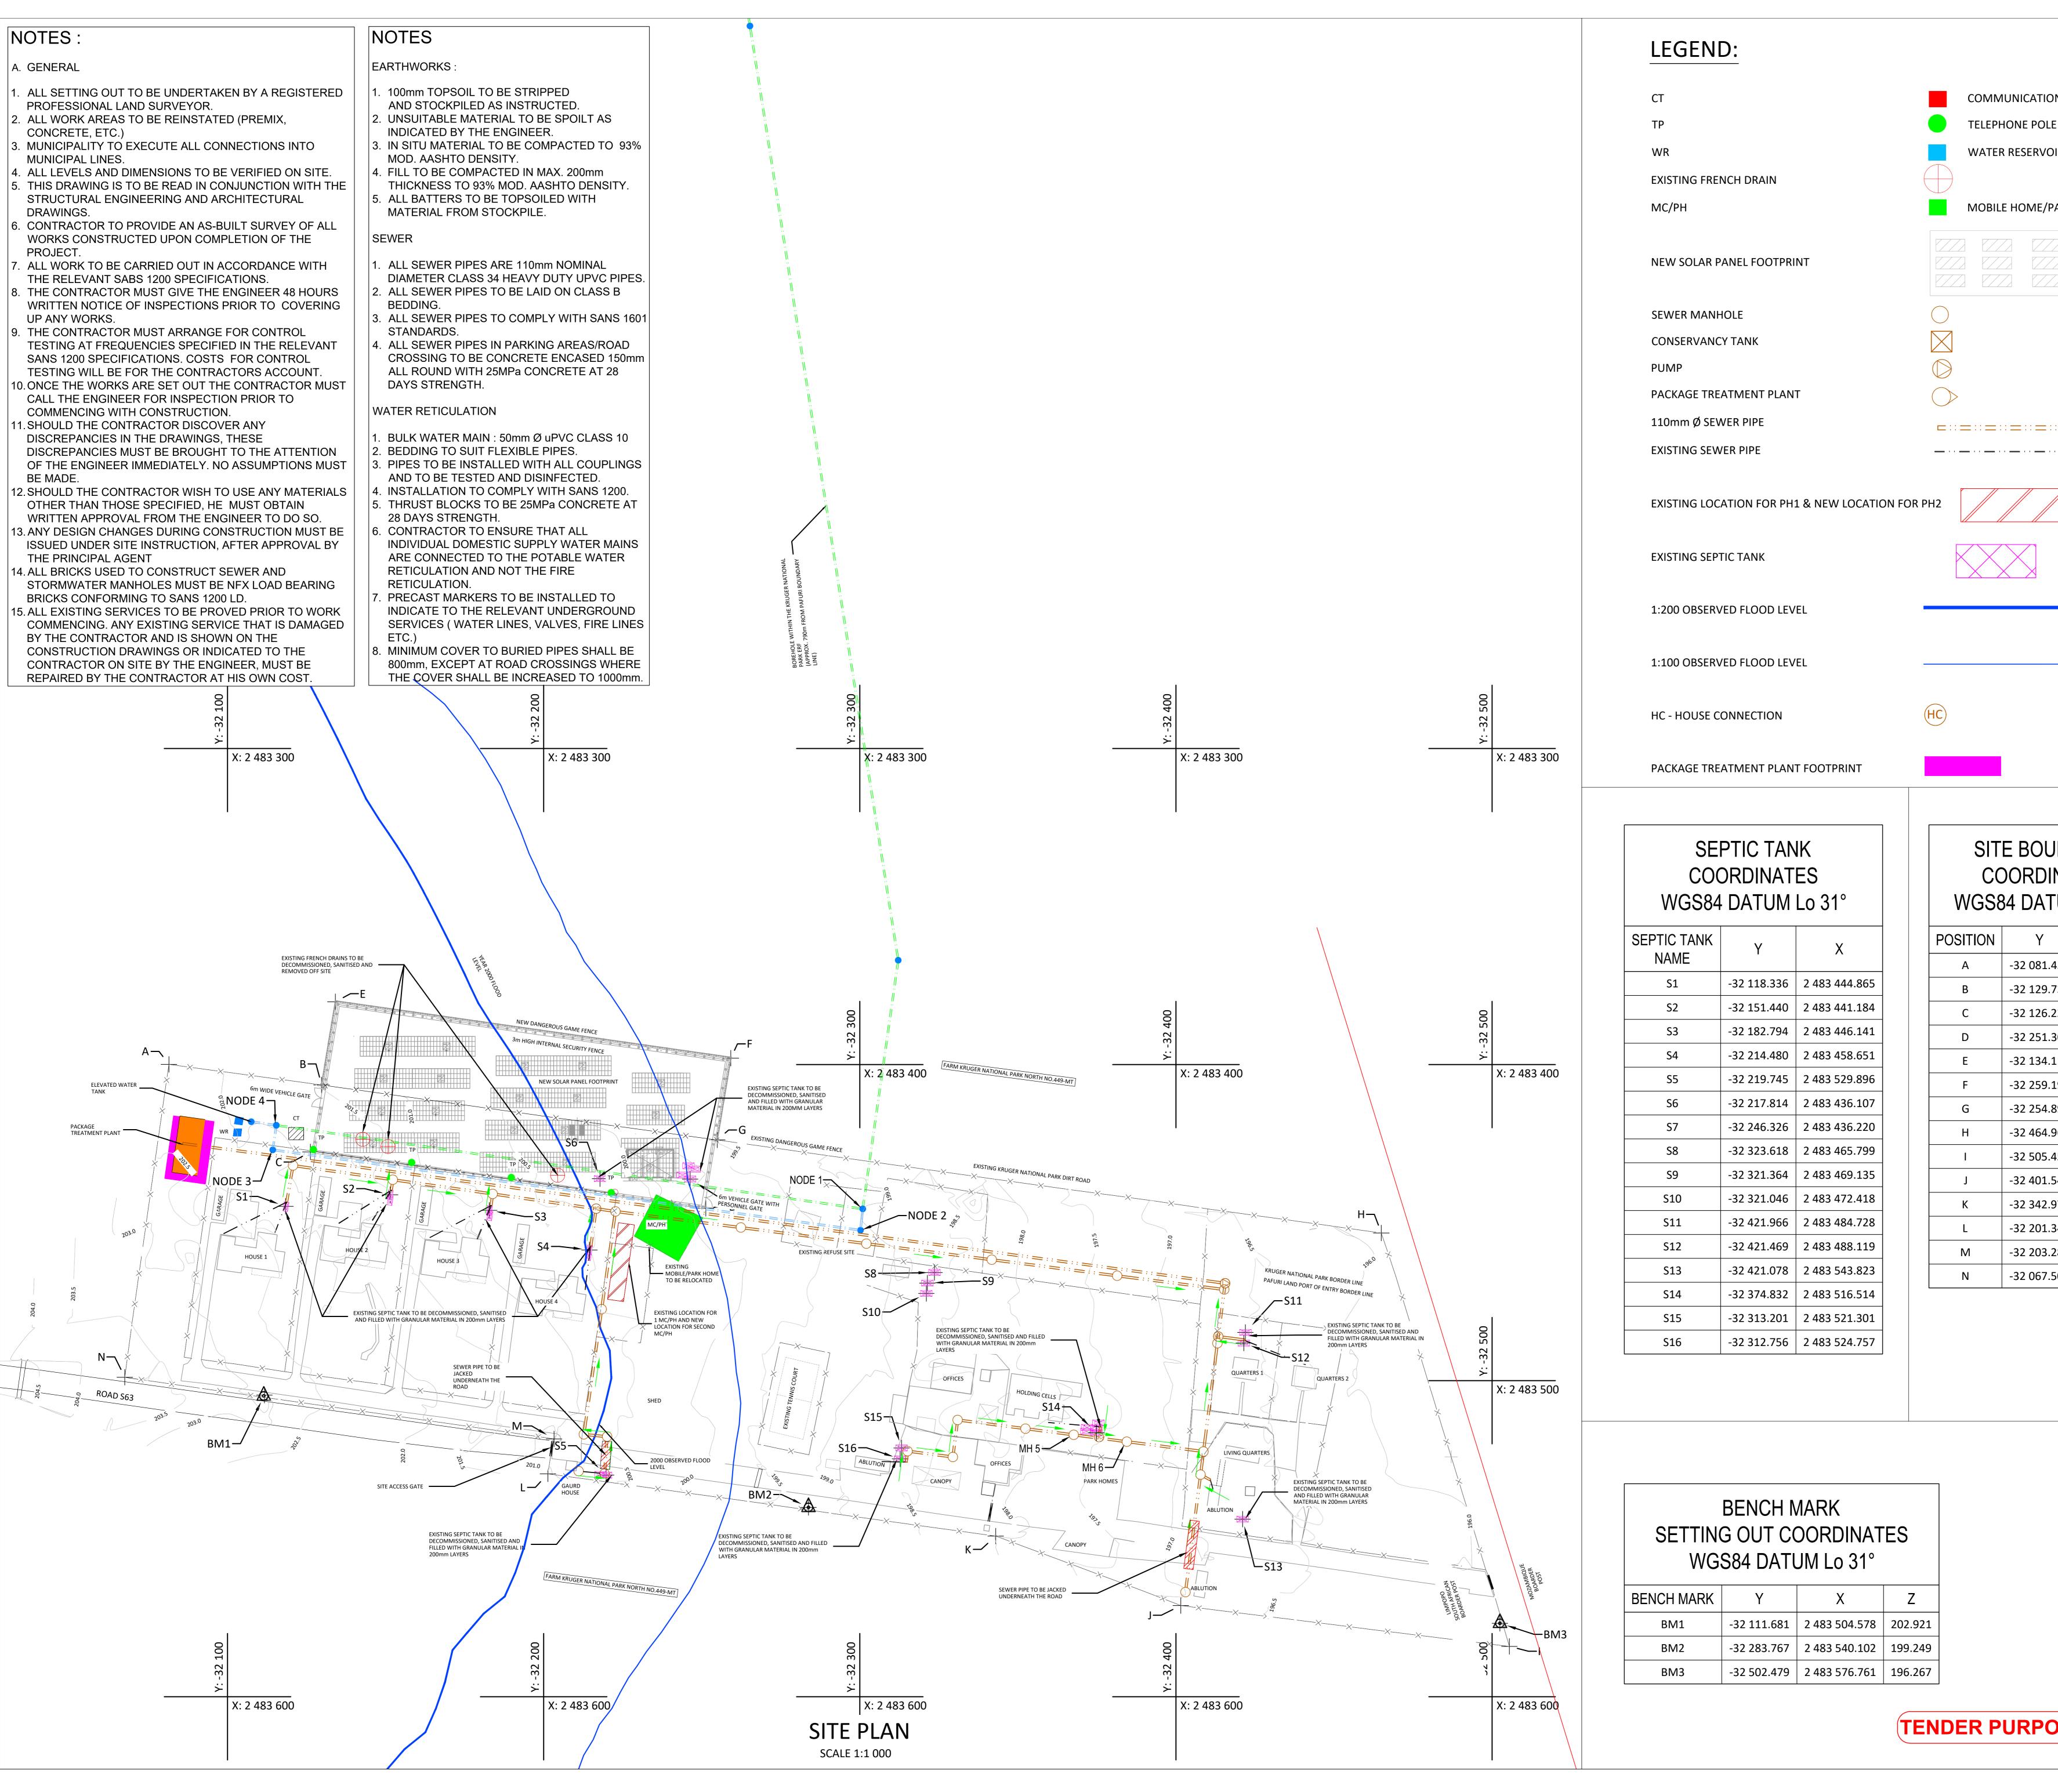


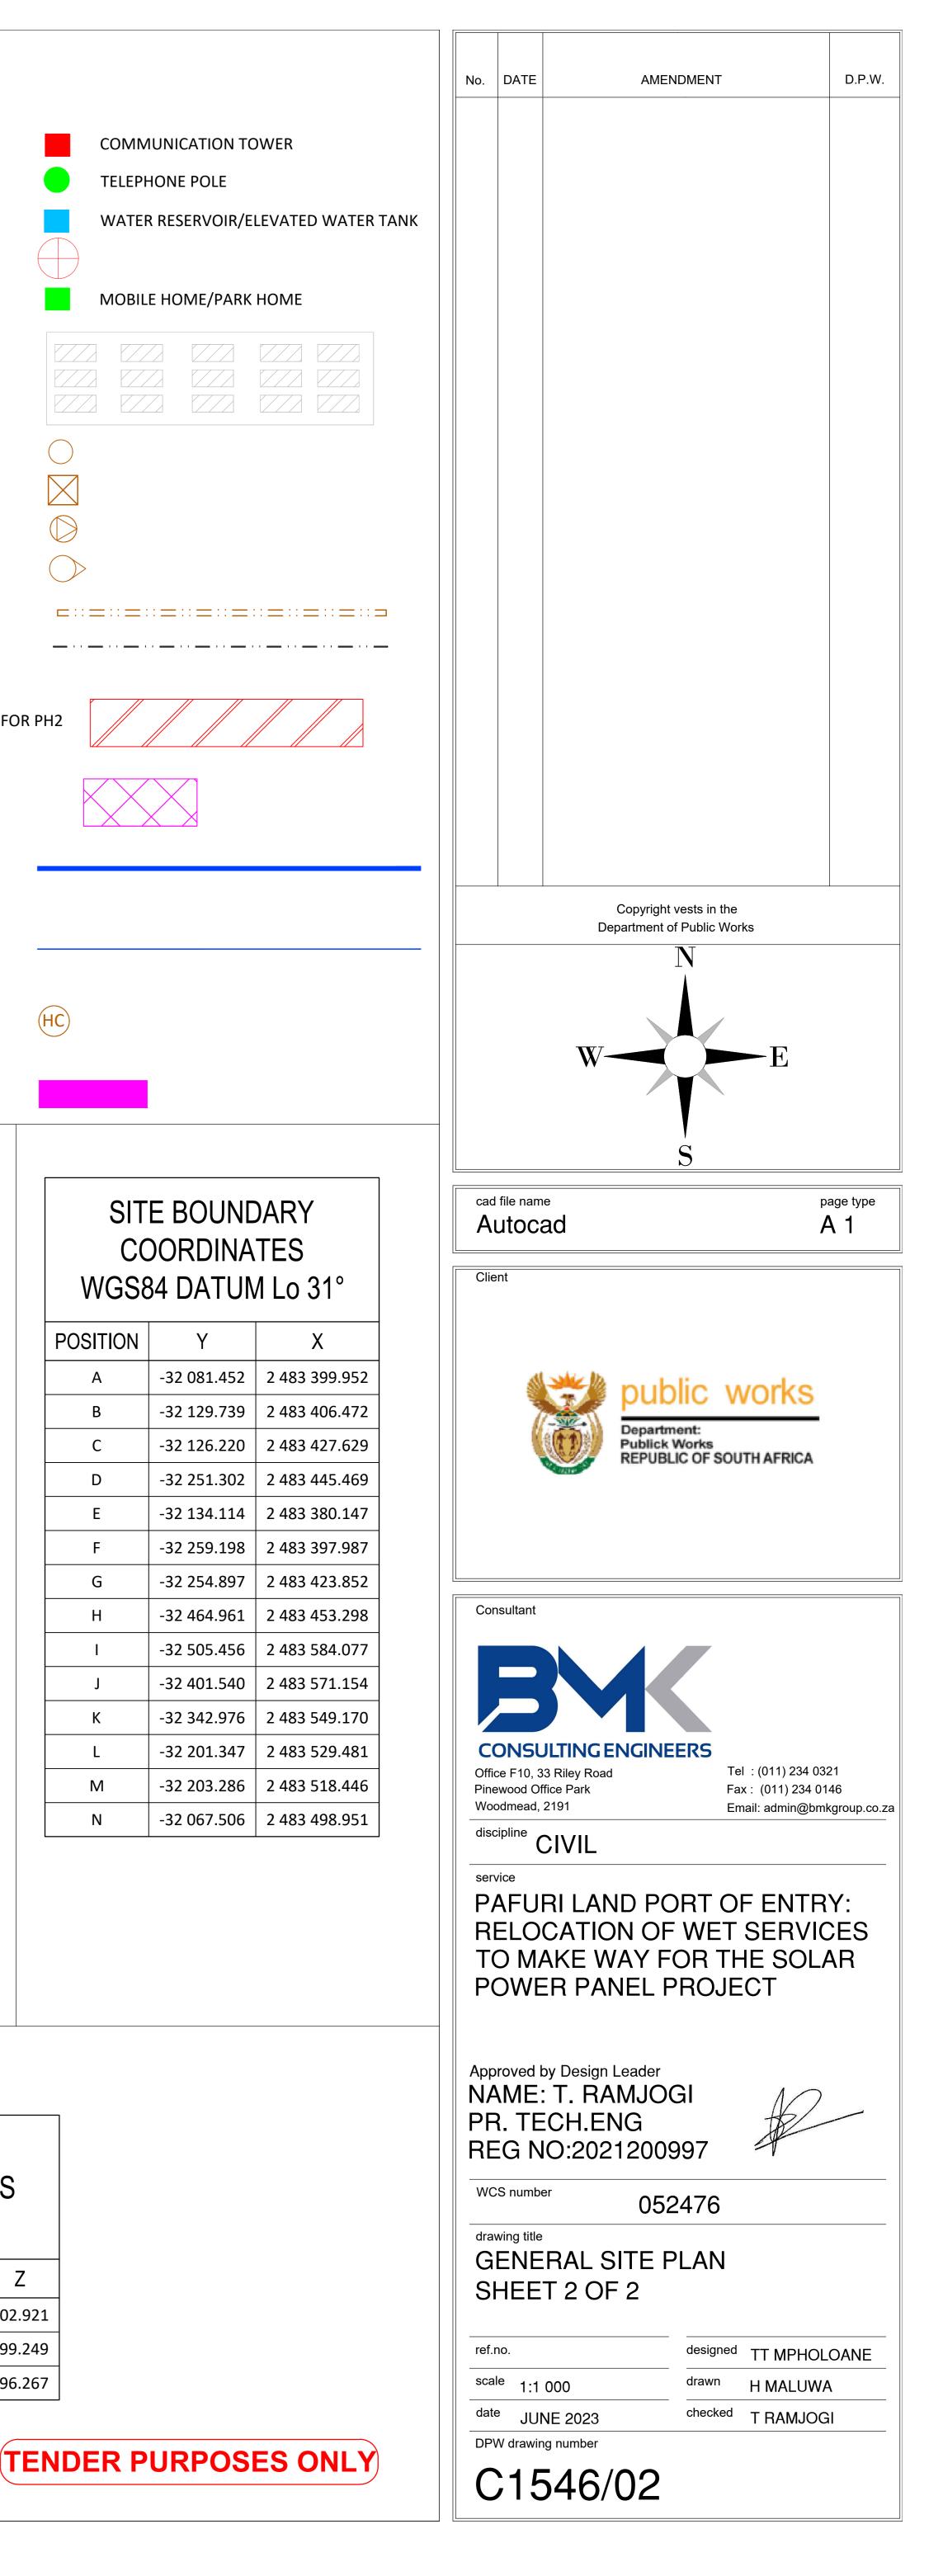

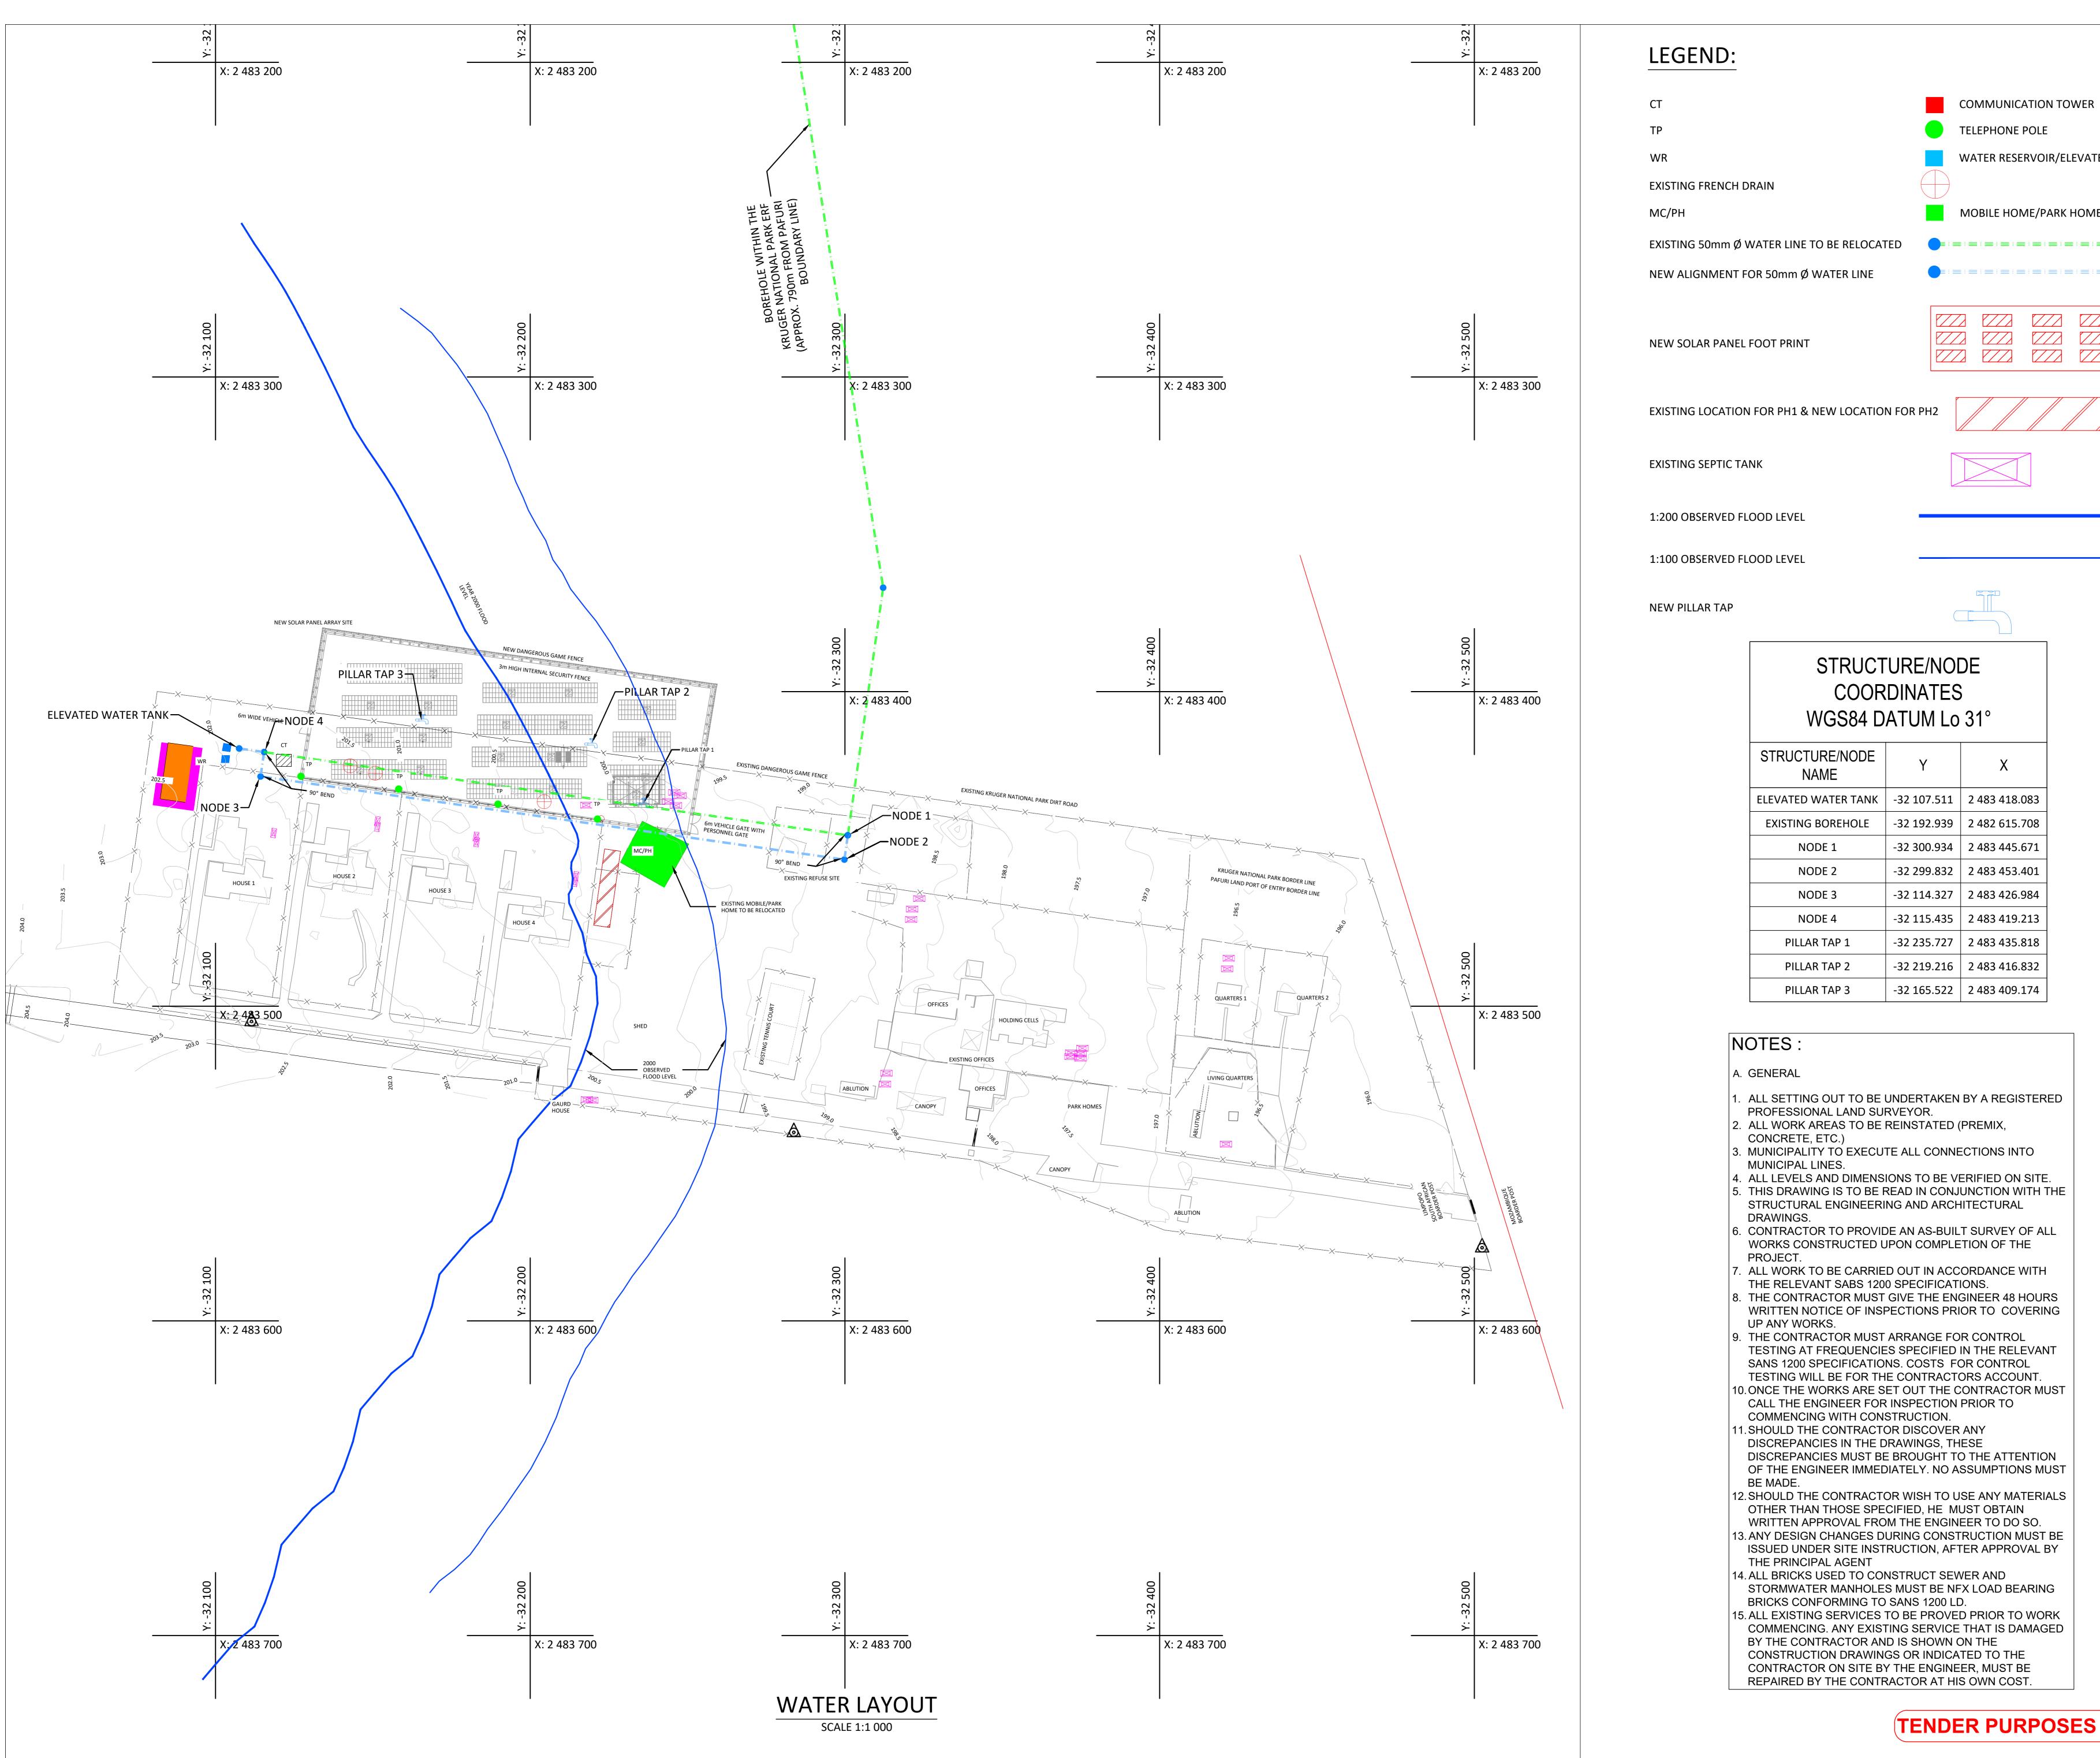

(TENDER PURPOSES ONLY)

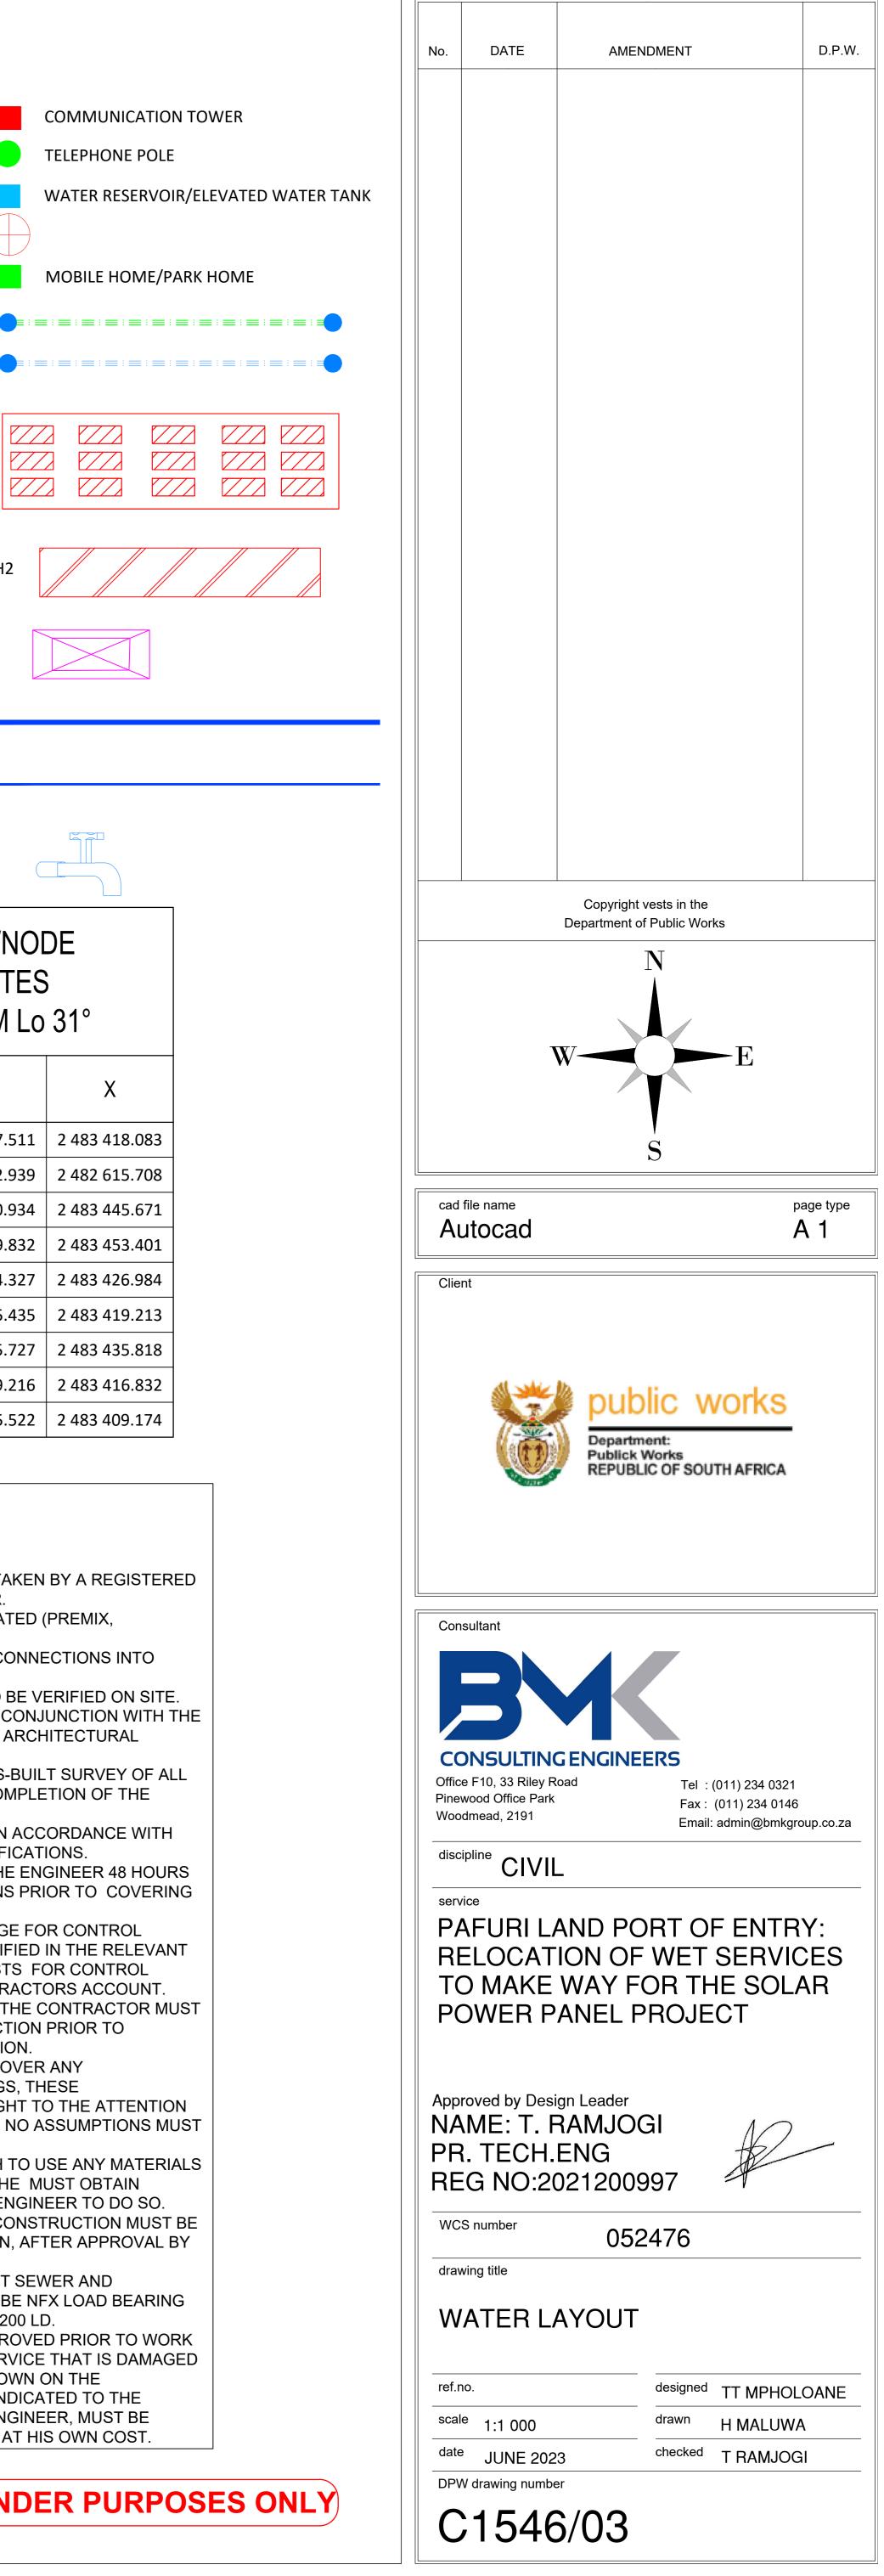

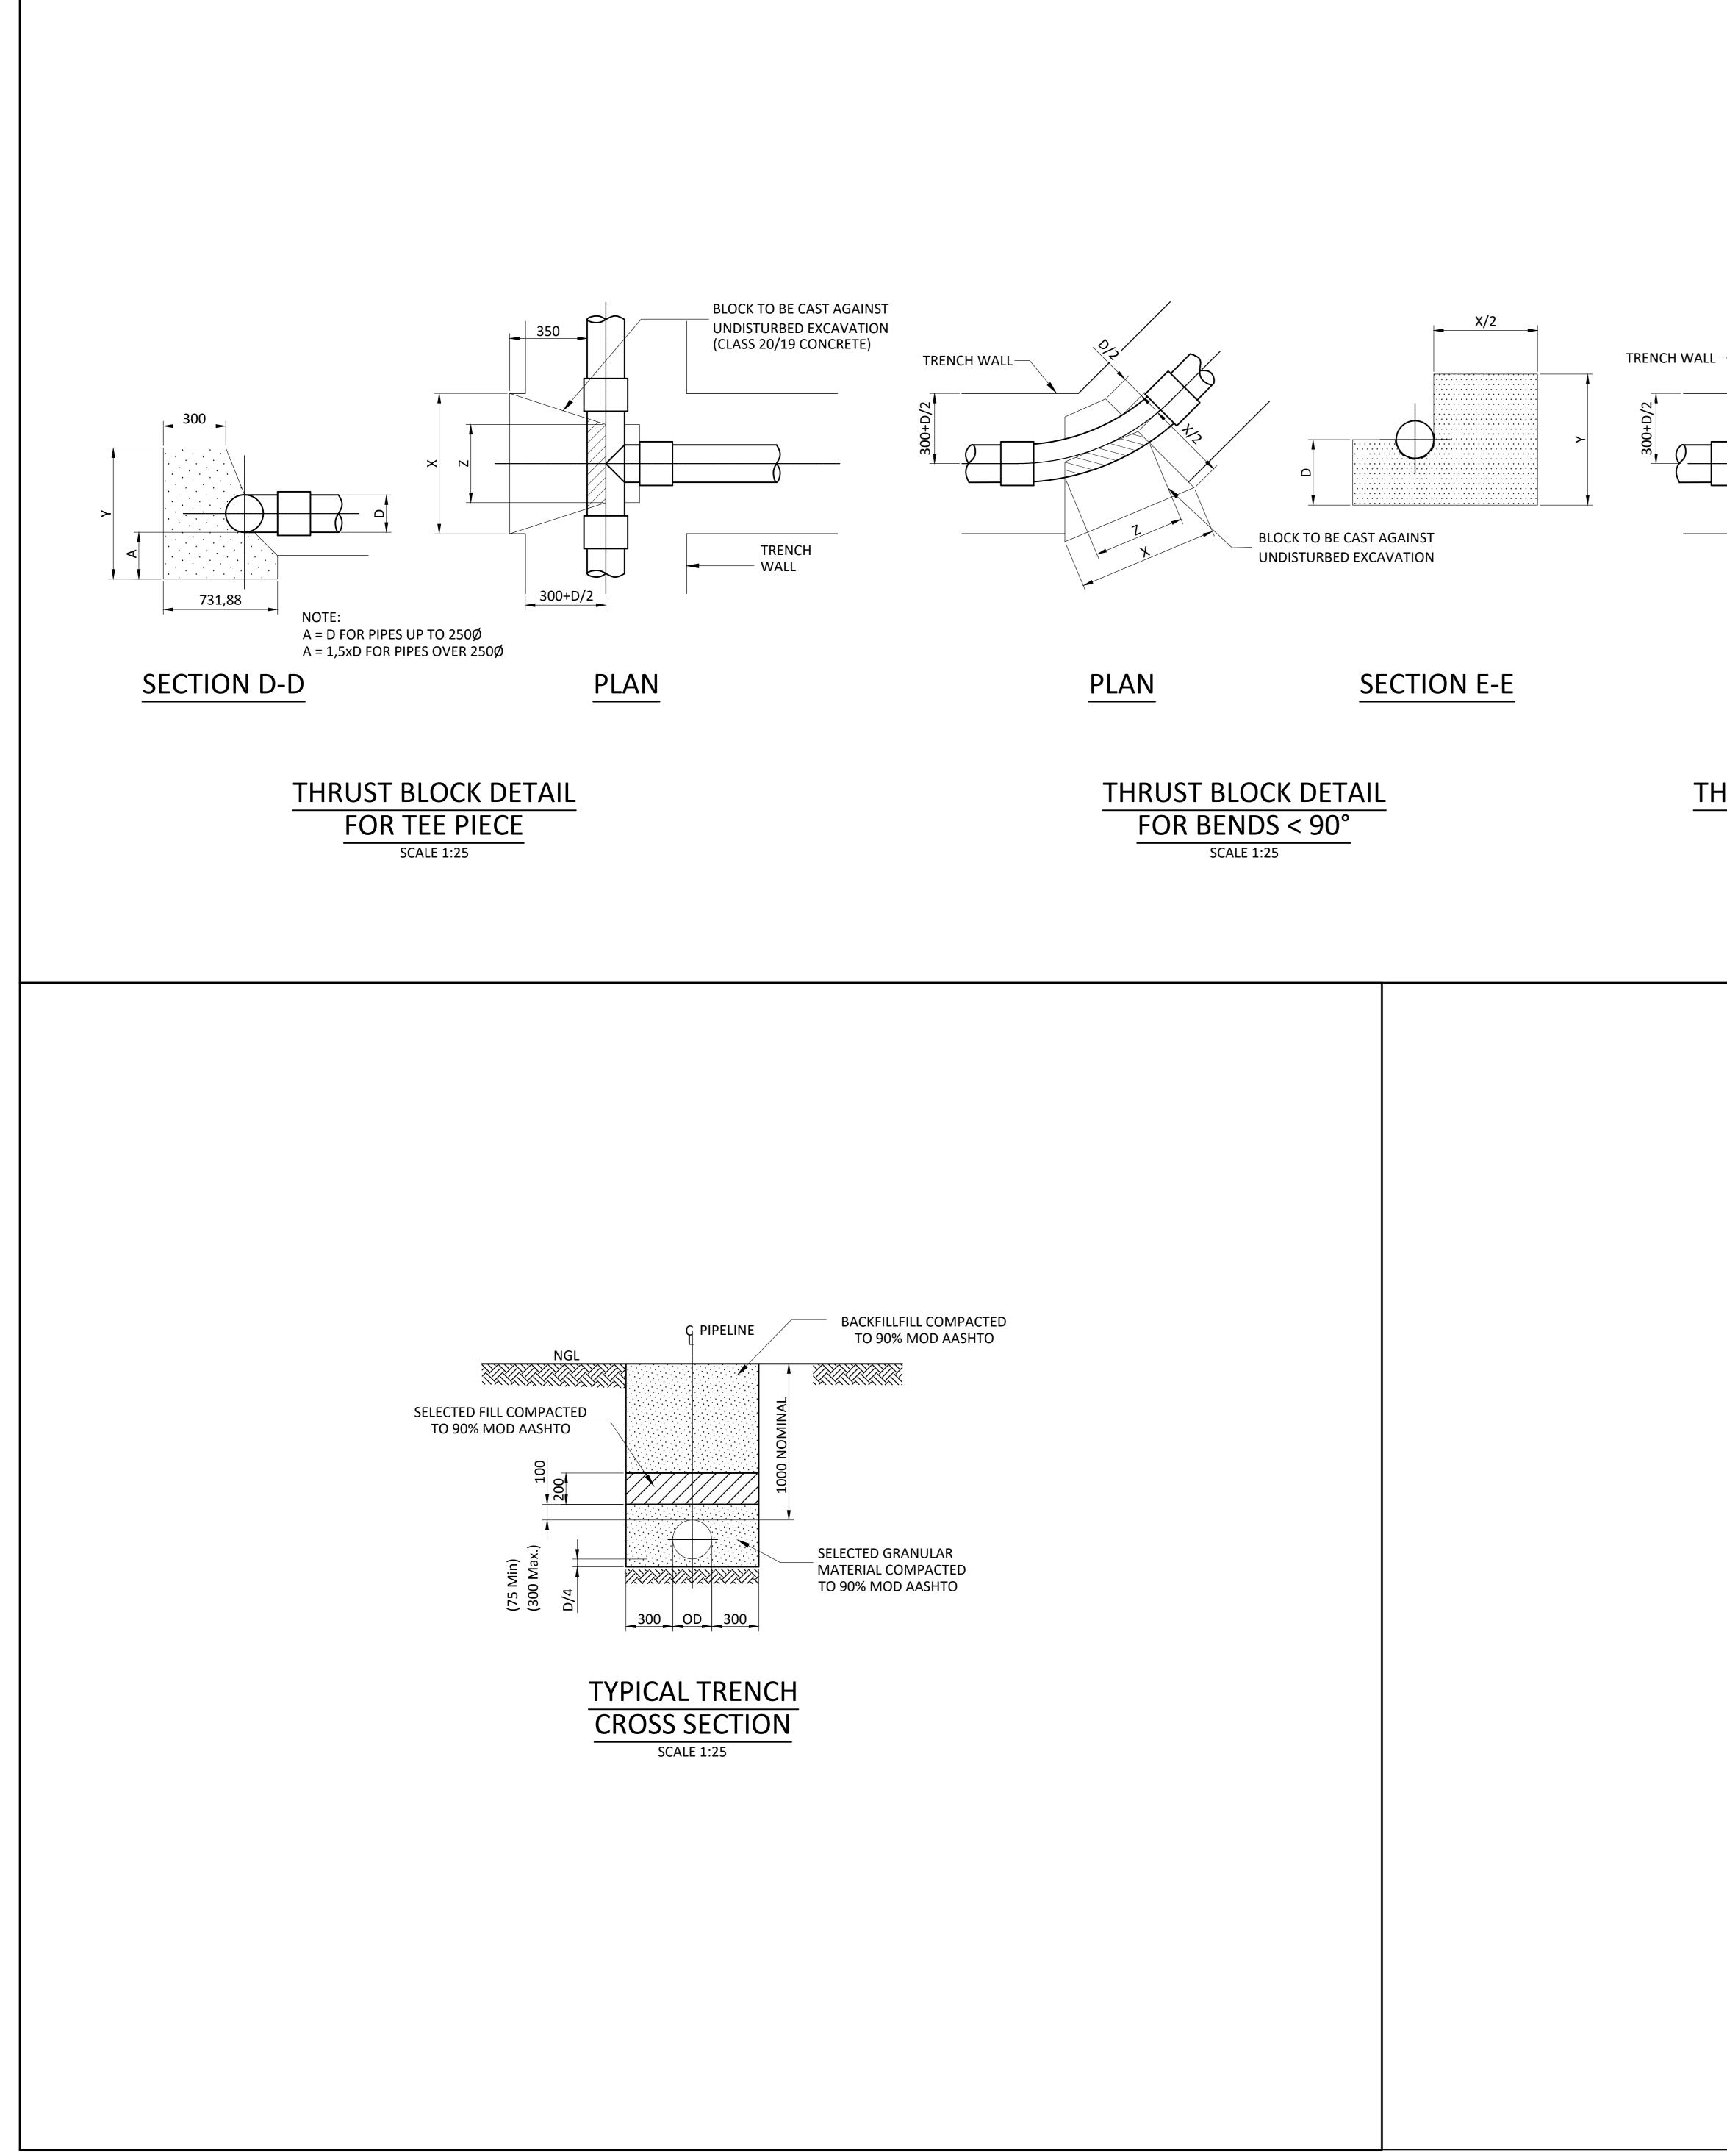

	TH		CK FOR TE	
	PIPE DIAMETER	Х	Y	
	75	500	300	
	150	520	300	
	200	625	400	
			OR 11,25° PIPELINES	
	PIPE DIAMETER	Х	Y	
X	75	500	300	
Z	150	610	300	
-L Y = DEPTH OF BLOCK	200	610	400	
			OR 22,5°	
	IN	PRESSURE	PIPELINES	5
	PIPE DIAMETER	Х	Y	
	75	500	300	
	150	650	300	
BLOCK TO BE CAST AGAINST	200	660	400	
UNDISTURBED EXCAVATION (CLASS 20/19 CONCRETE)			FOR 45° B PIPELINES	
	PIPE DIAMETER	Х	Y	
PLAN	75	500	300	
	150	780	300	
	200	800	400	
HRUST BLOCK DETAIL			FOR 90° B PIPELINES	
FOR 90° BENDS	PIPE DIAMETER	Х	Y	
SCALE 1:25	75	500	300	
	150	1000	600	
	200	1300	800	

A.	GENERAL
1.	ALL SETTING OUT TO BE UNDERTAKEN BY A REGISTERED
	PROFESSIONAL LAND SURVEYOR.
2.	ALL WORK AREAS TO BE REINSTATED (PREMIX,
_	CONCRETE, ETC.)
3.	MUNICIPALITY TO EXECUTE ALL CONNECTIONS INTO
Л	MUNICIPAL LINES. ALL LEVELS AND DIMENSIONS TO BE VERIFIED ON SITE.
	THIS DRAWING IS TO BE READ IN CONJUNCTION WITH THE
0.	STRUCTURAL ENGINEERING AND ARCHITECTURAL
	DRAWINGS.
6.	CONTRACTOR TO PROVIDE AN AS-BUILT SURVEY OF ALL
	WORKS CONSTRUCTED UPON COMPLETION OF THE
7	PROJECT. ALL WORK TO BE CARRIED OUT IN ACCORDANCE WITH
1.	THE RELEVANT SABS 1200 SPECIFICATIONS.
8.	THE CONTRACTOR MUST GIVE THE ENGINEER 48 HOURS
	WRITTEN NOTICE OF INSPECTIONS PRIOR TO COVERING
	UP ANY WORKS.
9.	THE CONTRACTOR MUST ARRANGE FOR CONTROL
	TESTING AT FREQUENCIES SPECIFIED IN THE RELEVANT
	SANS 1200 SPECIFICATIONS. COSTS FOR CONTROL TESTING WILL BE FOR THE CONTRACTORS ACCOUNT.
10	ONCE THE WORKS ARE SET OUT THE CONTRACTOR MUST
10.	CALL THE ENGINEER FOR INSPECTION PRIOR TO
	COMMENCING WITH CONSTRUCTION.
11.	SHOULD THE CONTRACTOR DISCOVER ANY
	DISCREPANCIES IN THE DRAWINGS, THESE
	DISCREPANCIES MUST BE BROUGHT TO THE ATTENTION
	OF THE ENGINEER IMMEDIATELY. NO ASSUMPTIONS MUST BE MADE.
12	SHOULD THE CONTRACTOR WISH TO USE ANY MATERIALS
	OTHER THAN THOSE SPECIFIED, HE MUST OBTAIN
	WRITTEN APPROVAL FROM THE ENGINEER TO DO SO.
13.	ANY DESIGN CHANGES DURING CONSTRUCTION MUST BE
	ISSUED UNDER SITE INSTRUCTION, AFTER APPROVAL BY
11	THE PRINCIPAL AGENT ALL BRICKS USED TO CONSTRUCT SEWER AND
14.	STORMWATER MANHOLES MUST BE NFX LOAD BEARING
	BRICKS CONFORMING TO SANS 1200 LD.
15.	ALL EXISTING SERVICES TO BE PROVED PRIOR TO WORK
	COMMENCING. ANY EXISTING SERVICE THAT IS DAMAGED
	BY THE CONTRACTOR AND IS SHOWN ON THE
	CONSTRUCTION DRAWINGS OR INDICATED TO THE
	CONTRACTOR ON SITE BY THE ENGINEER, MUST BE REPAIRED BY THE CONTRACTOR AT HIS OWN COST.
	NEFAINED DT THE CONTRACTOR AT HIS OWN COST.

NOTES :

