



SECTION B - B

SCALE - 1 : 5

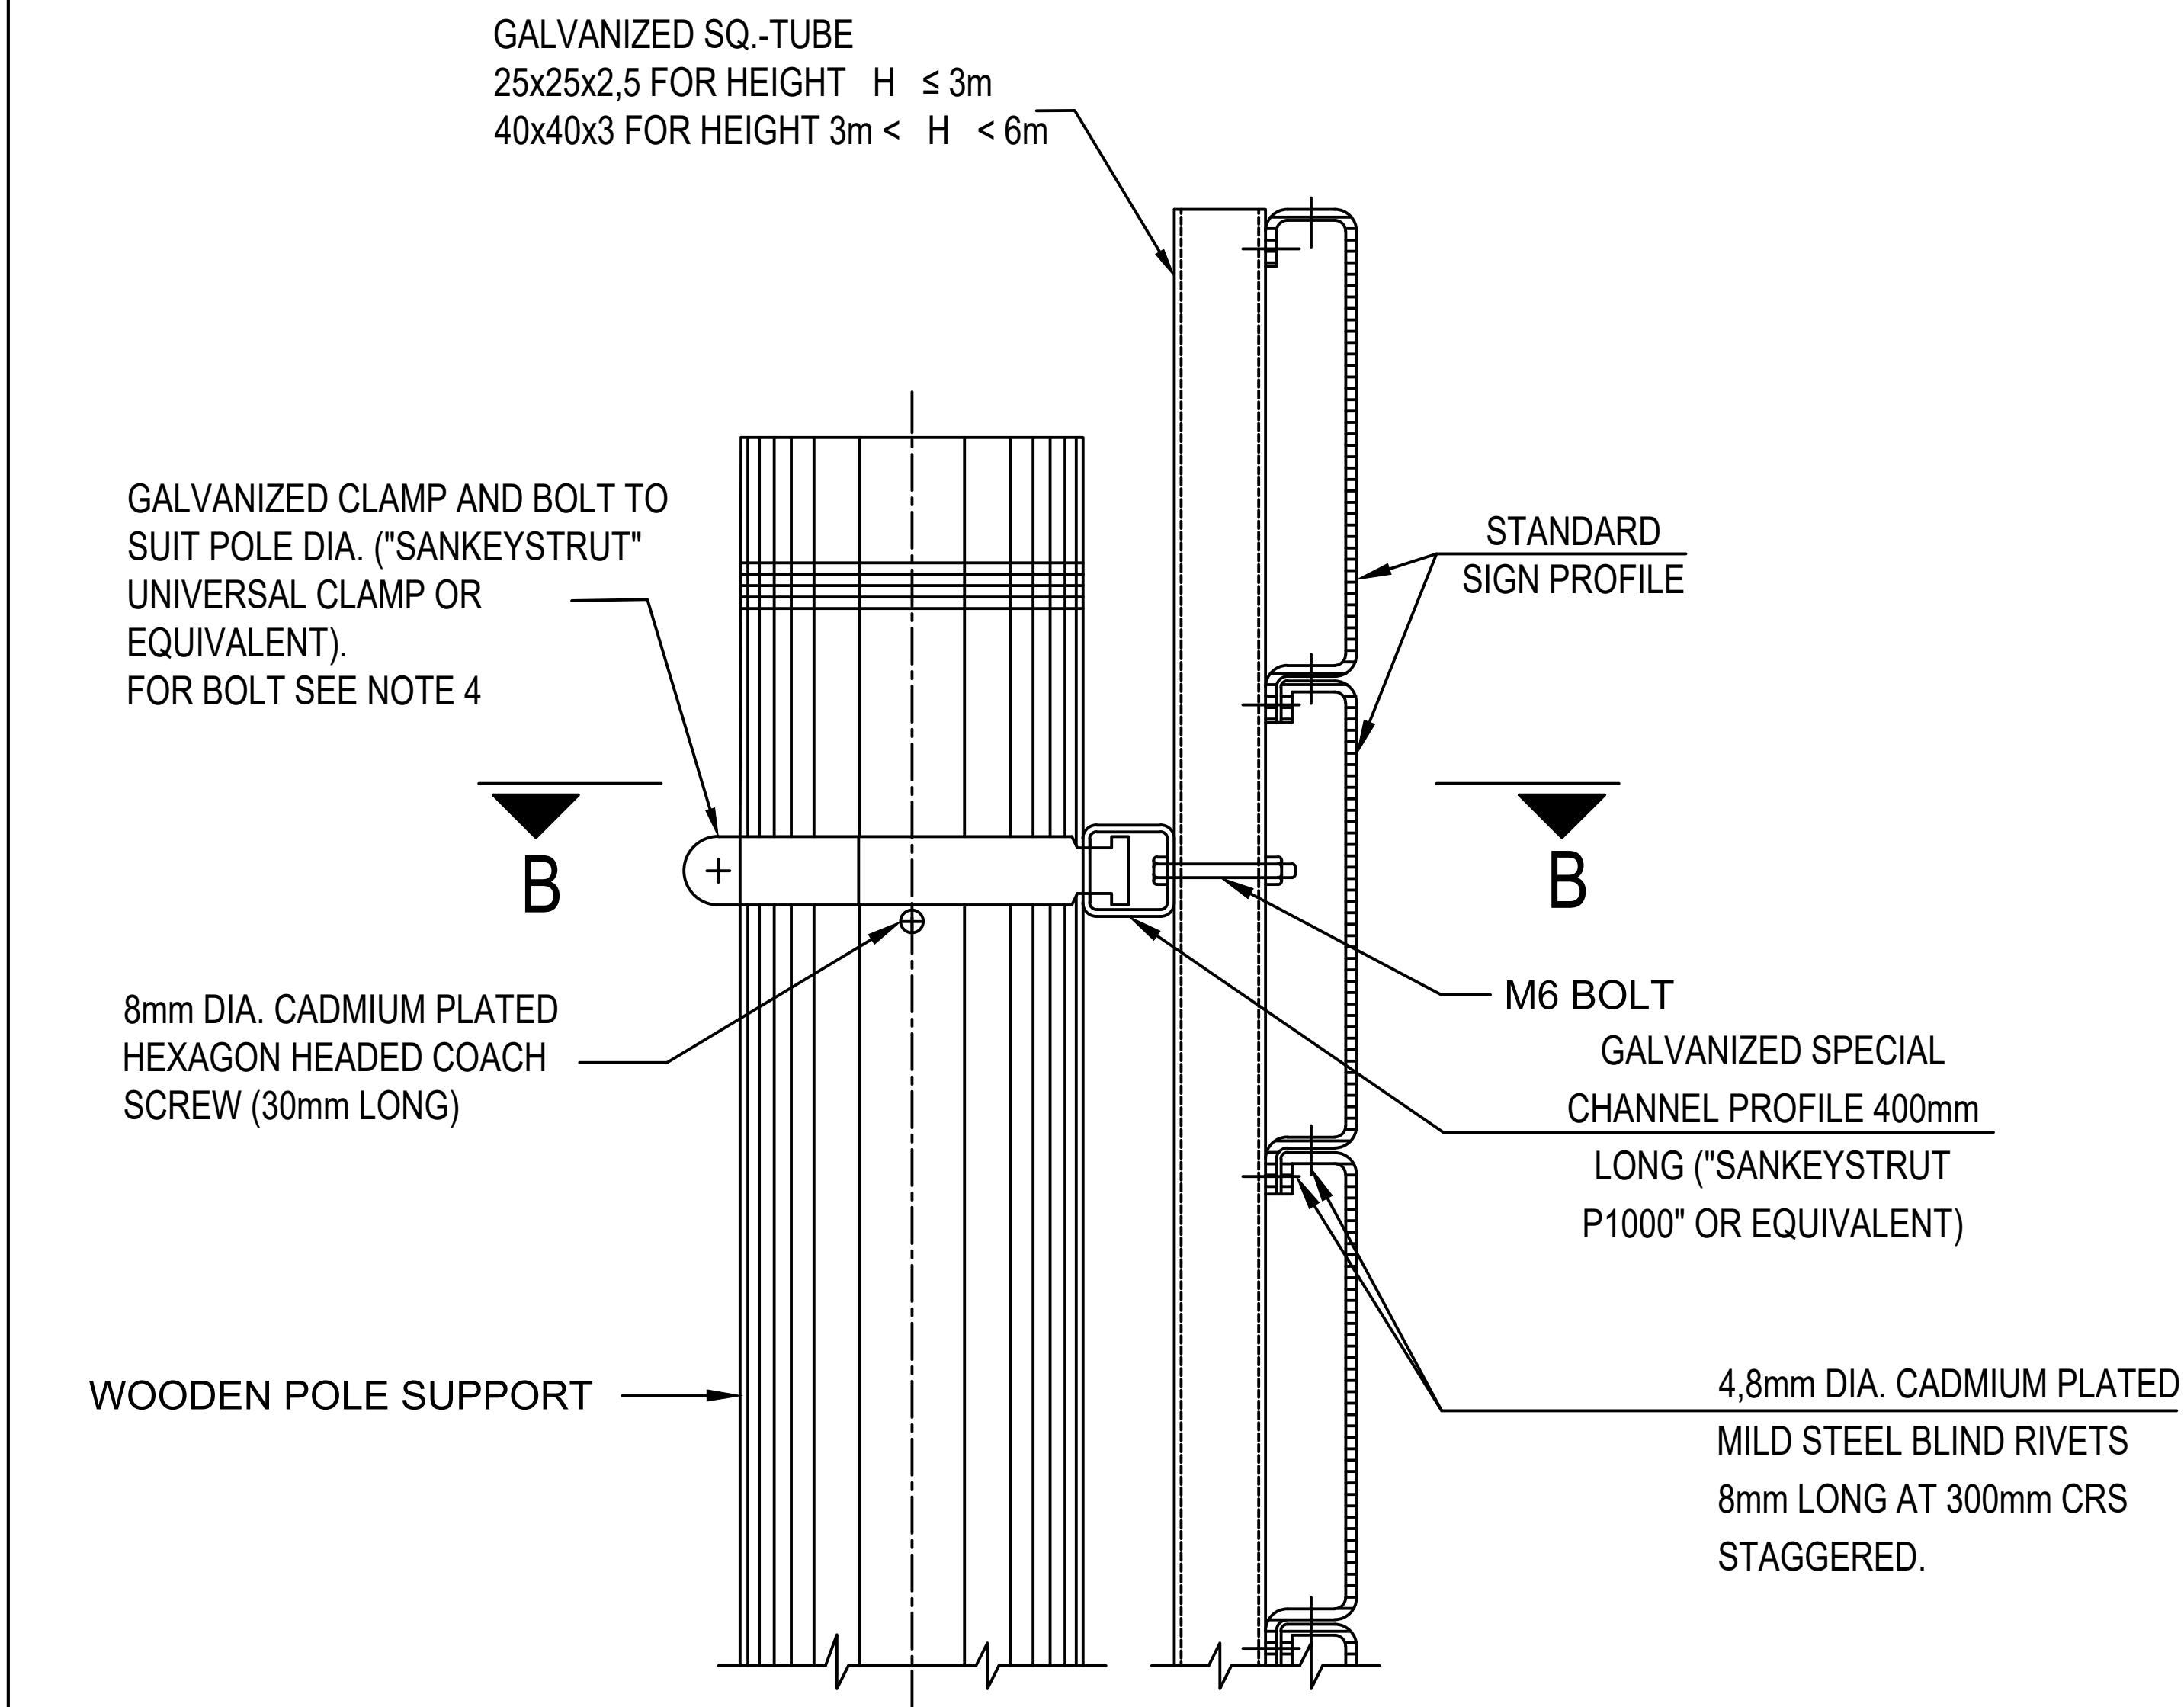

ELEVATION A-A

SCALE 1:5

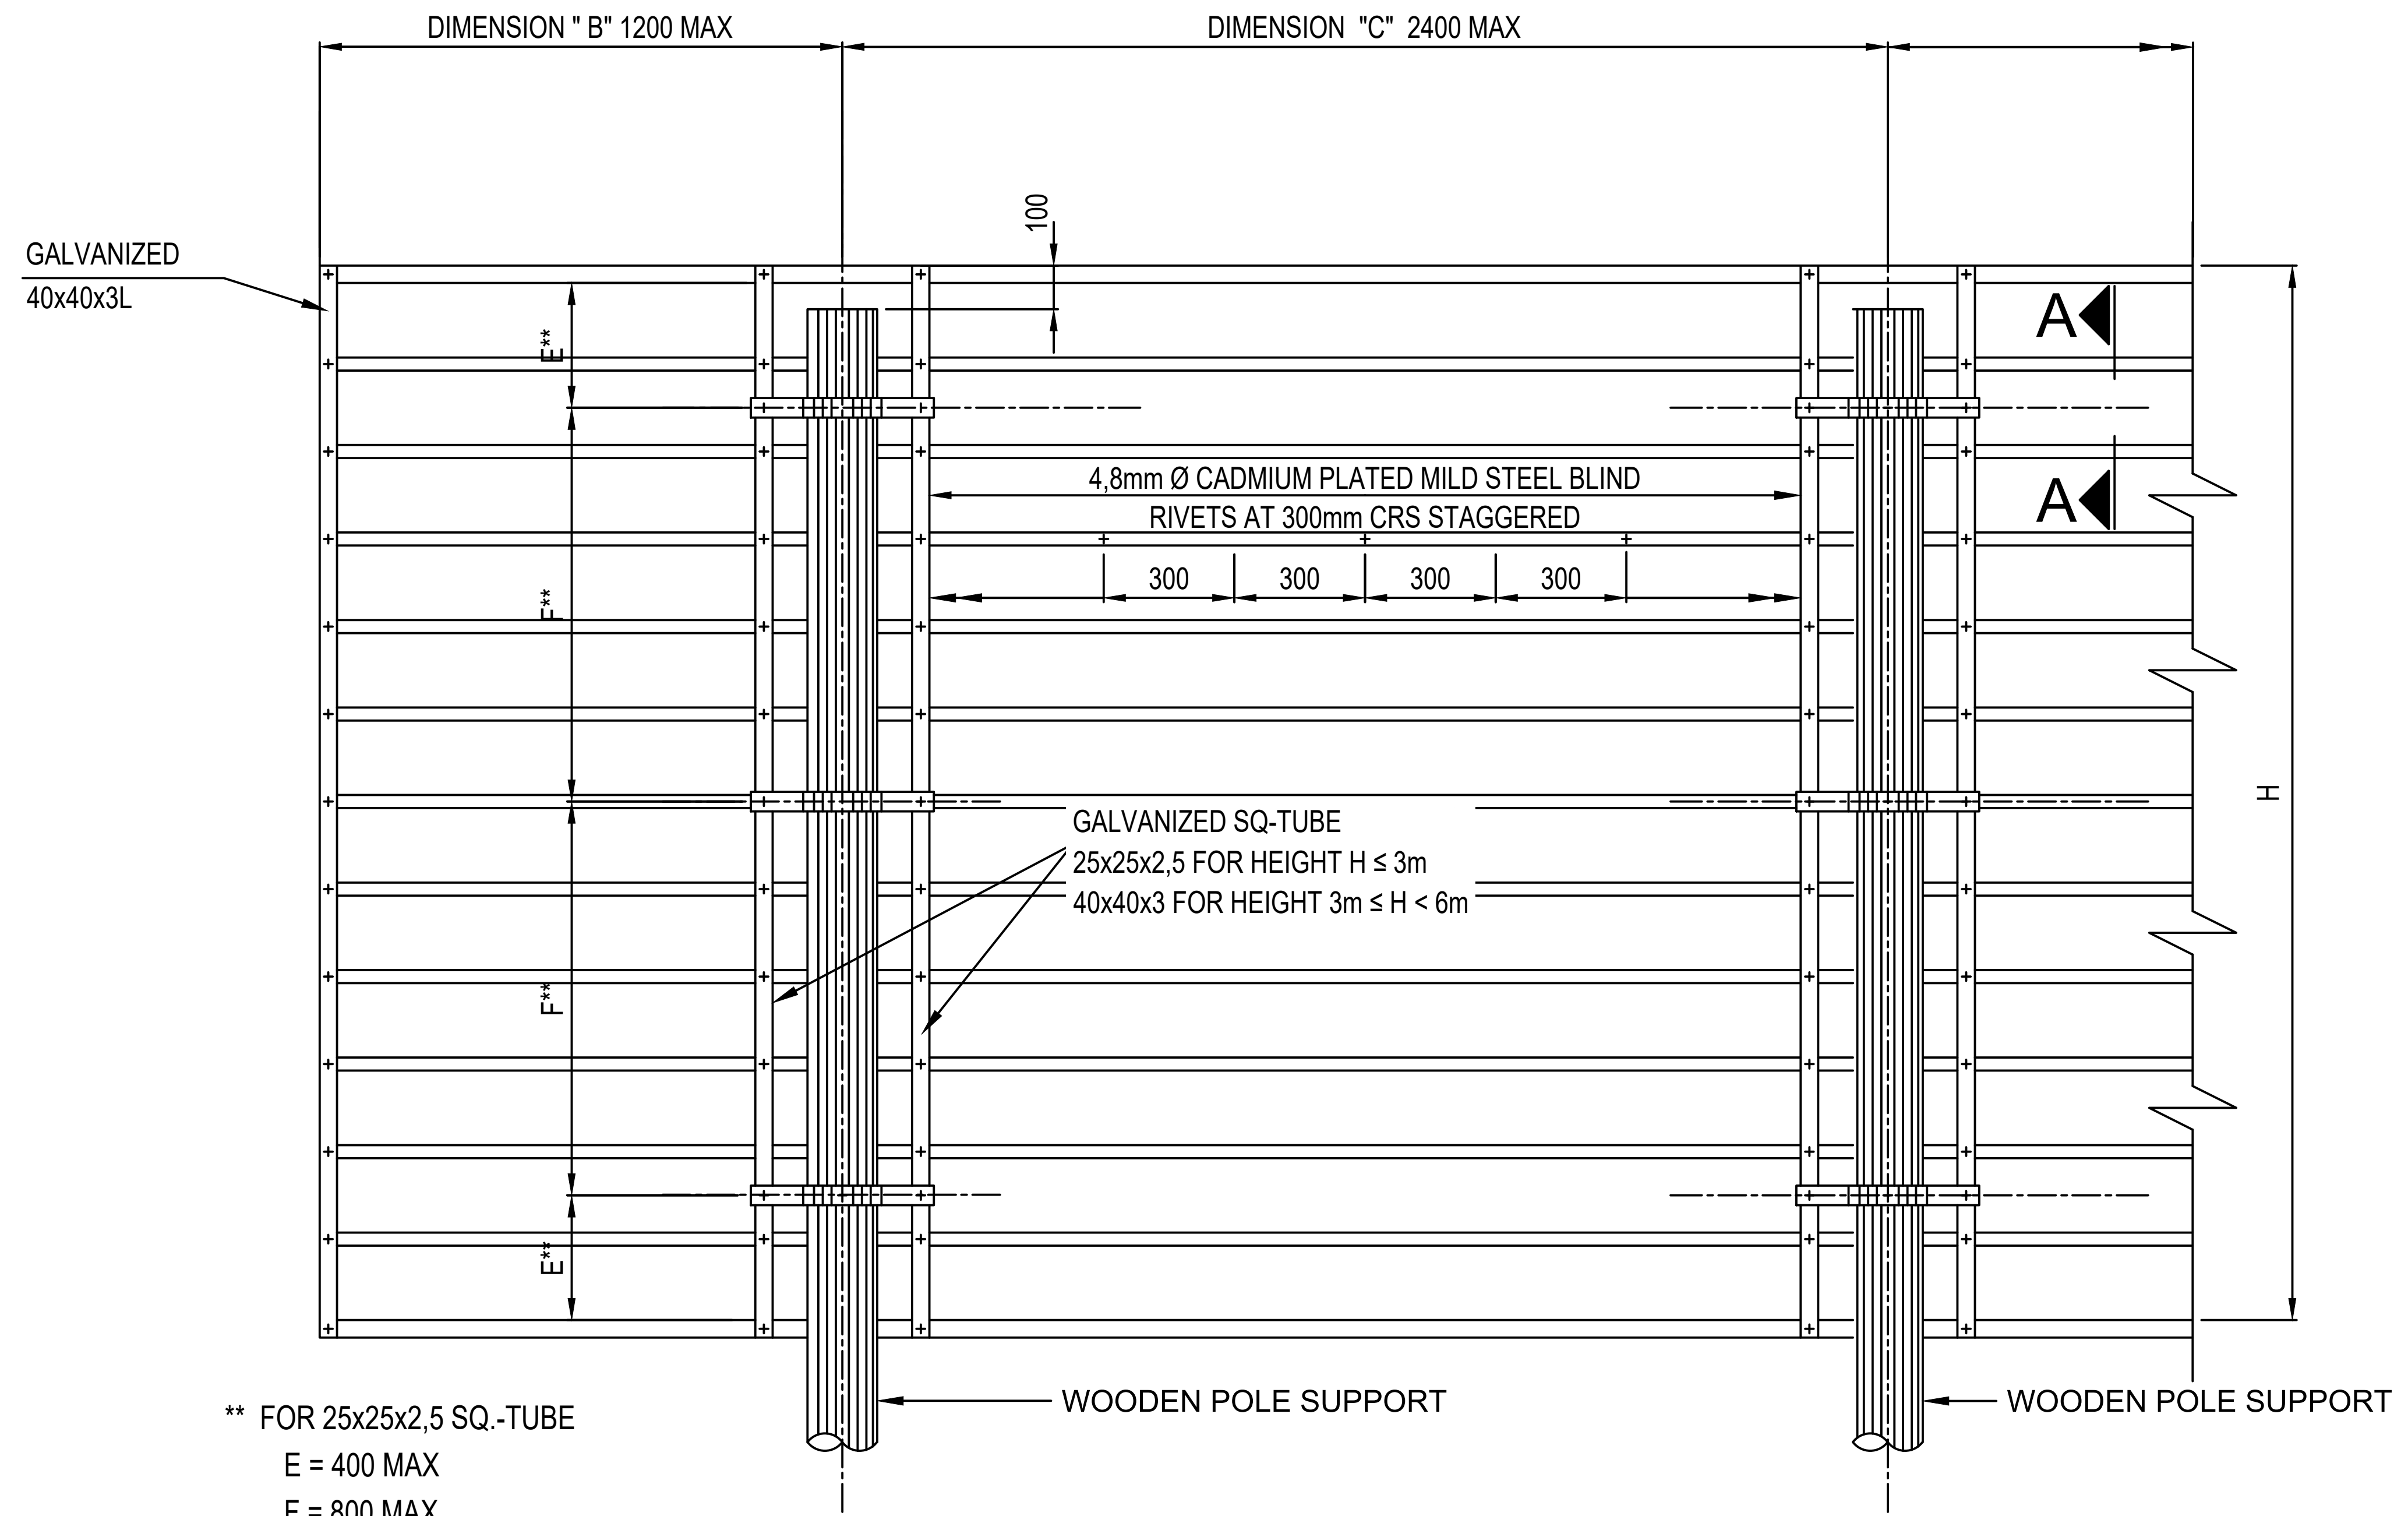

REAR ELEVATION

SCALE 1:20

NOTES :

THE ROAD SIGN FACES SHALL BE MANUFACTURED AND ERECTED IN ACCORDANCE WITH THE FOLLOWING REQUIREMENTS :

1. THE STANDARD SIGN PROFILE IF APPLICABLE SHALL BE MADE IN ACCORDANCE WITH THE DETAILS SHOWN ON DRAWING TD-R-RS-101.
2. A SIGN FACE WHICH EXCEEDS 6m LENGTH MAY BE MANUFACTURED IN TWO SECTIONS. THE JOINT SHALL BE MADE IN ACCORDANCE WITH DETAILS SHOWN ON DRAWING TD-R-RS-101.
3. STRUCTURAL STEEL SECTIONS SHALL BE MILD STEEL CONFORMING TO THE REQUIREMENTS OF SANS 1431, GRADE 300W. RECTANGULAR HOLLOW SECTION AND SPECIAL CHANNEL PROFILES MAY BE COLD FORMED OF COMMERCIAL QUALITY MILD STEEL. ALL SECTIONS SHALL BE HOT-DIP GALVANISED IN ACCORDANCE WITH THE REQUIREMENTS OF SANS 121 : 2000 (ISO 1461 : 1999).
4. BOLTS, WASHERS AND NUTS SHALL COMPLY WITH THE REQUIREMENTS OF SANS 1700-5-1 AND SHALL BE GALVANISED IN ACCORDANCE WITH THE REQUIREMENTS OF SANS 121 : 2000 (ISO 1461 : 1999).
5. BLIND RIVETS SHALL BE 4.8mm DIA CADMIUM PLATED MILD STEEL.
6. REFERENCE MUST BE MADE TO THE RELEVANT ROAD SIGNS DETAIL DRAWING FOR DETAILS OF THE ROAD SYMBOLS AND LEGEND FOR EACH INDIVIDUAL SIGN.

CONSTRUCTION RECORD (AS-BUILT)				DESIGNED BY		CONSULTANT APPROVAL	HEAD OFFICE	EASTERN REGION	ACCEPTANCE	PROJECT DESCRIPTION	PROJECT NUMBER		
No.	DATE	REVISION	CONSULT. ENG.	Name:	Prof. Reg. No.						DRAWING LOCATION DATA	START	END
											ROUTE	N2	N2
											SECTION	21X	21X
											DRAWING km DISTANCE	60.1	102.0
											DRAWING TYPE		
											BRIDGE/STRUCTURE No.		
											CONSULTANT DRAWING No.		
											SANRAL DOCUMENT #		